

SITE WORK NOTES:

- COORDINATE ANY PLANTING AND LANDSCAPE REMOVAL WITH ARCHITECT AND OWNER PRIOR TO DISTURBING.
- COORDINATE WORK FOR NEW UTILITY SERVICES AS REQUIRED WITH APPROPRIATE AGENCIES. MARK-OUT ALL SITE UTILITIES PRIOR TO REMOVALS.
- 3. CONFIRM LOCATIONS OF NEW TANKS WITH UTILITY COMPANY PRIOR TO
- 4. PROVIDE 42" HIGH SAFETY GUARDRAILS AROUND EXCAVATED AREAS AS REQUIRED BY LOCAL CODES.
- 5. COORDINATE WITH OWNER'S IRRIGATION COMPANY PRIOR TO REMOVALS AND AFTER FOR REPAIRS TO SYSTEM.
- 6. REFER TO PROJECT SPECIFICATIONS FOR ADDITIONAL INFO, AS APPLICABLE
- 7. REFER TO PROPERTY SURVEY, PREPARED BY OTHERS, FOR ADDITIONAL INFORMATION NOT SHOWN HERE
- 8. PROVIDE TEMPORARY FENCING AND RELATED WORK, AS REQUIRED BY BUILDING DEPARTMENT
- BUILDING DEPARTMENT
- 9. REFER TO SHEET A-001 FOR ADDITIONAL NOTES, AS APPLICABLE.
- 10. EXISTING ADJACENT STRUCTURES SHALL BE ADEQUATELY SHORED, BRACED AND UNDERPINNED AS NECESSARY.

JOSEPH PAGAC ARCHITECT P.C.

16 Library Avenue, Suite D Westhampton Beach, New York 11978 P: 631.557.0070

PROJECT NO.: 2213

DATE: 1/12/2023

DRAWN BY: CD CHECKED BY: JP

DRAWING TITLE


PROPOSED SITE PLAN


SCALE: AS NOTED

A-010


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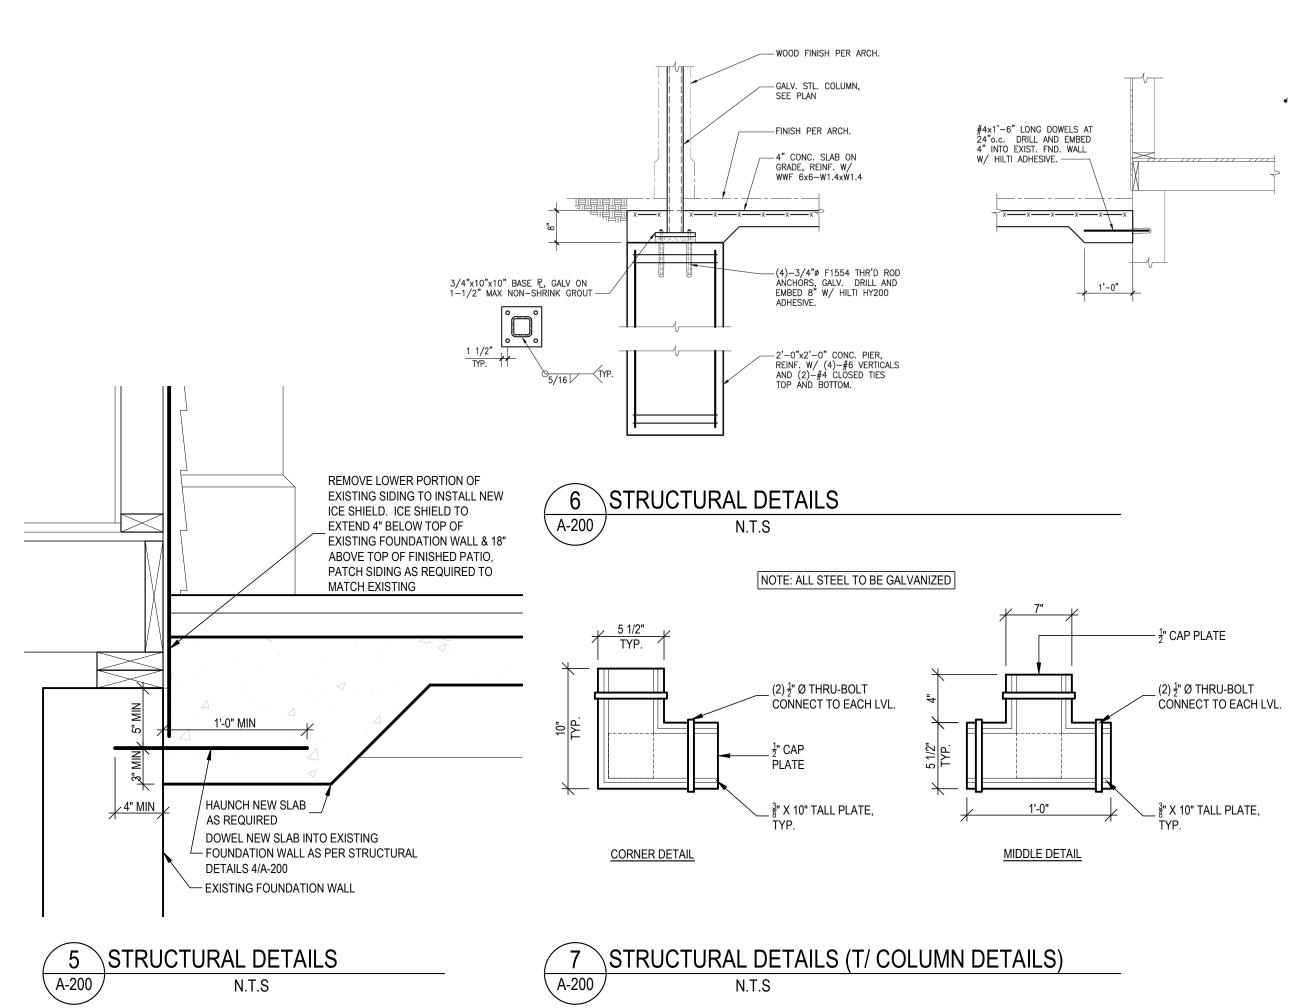





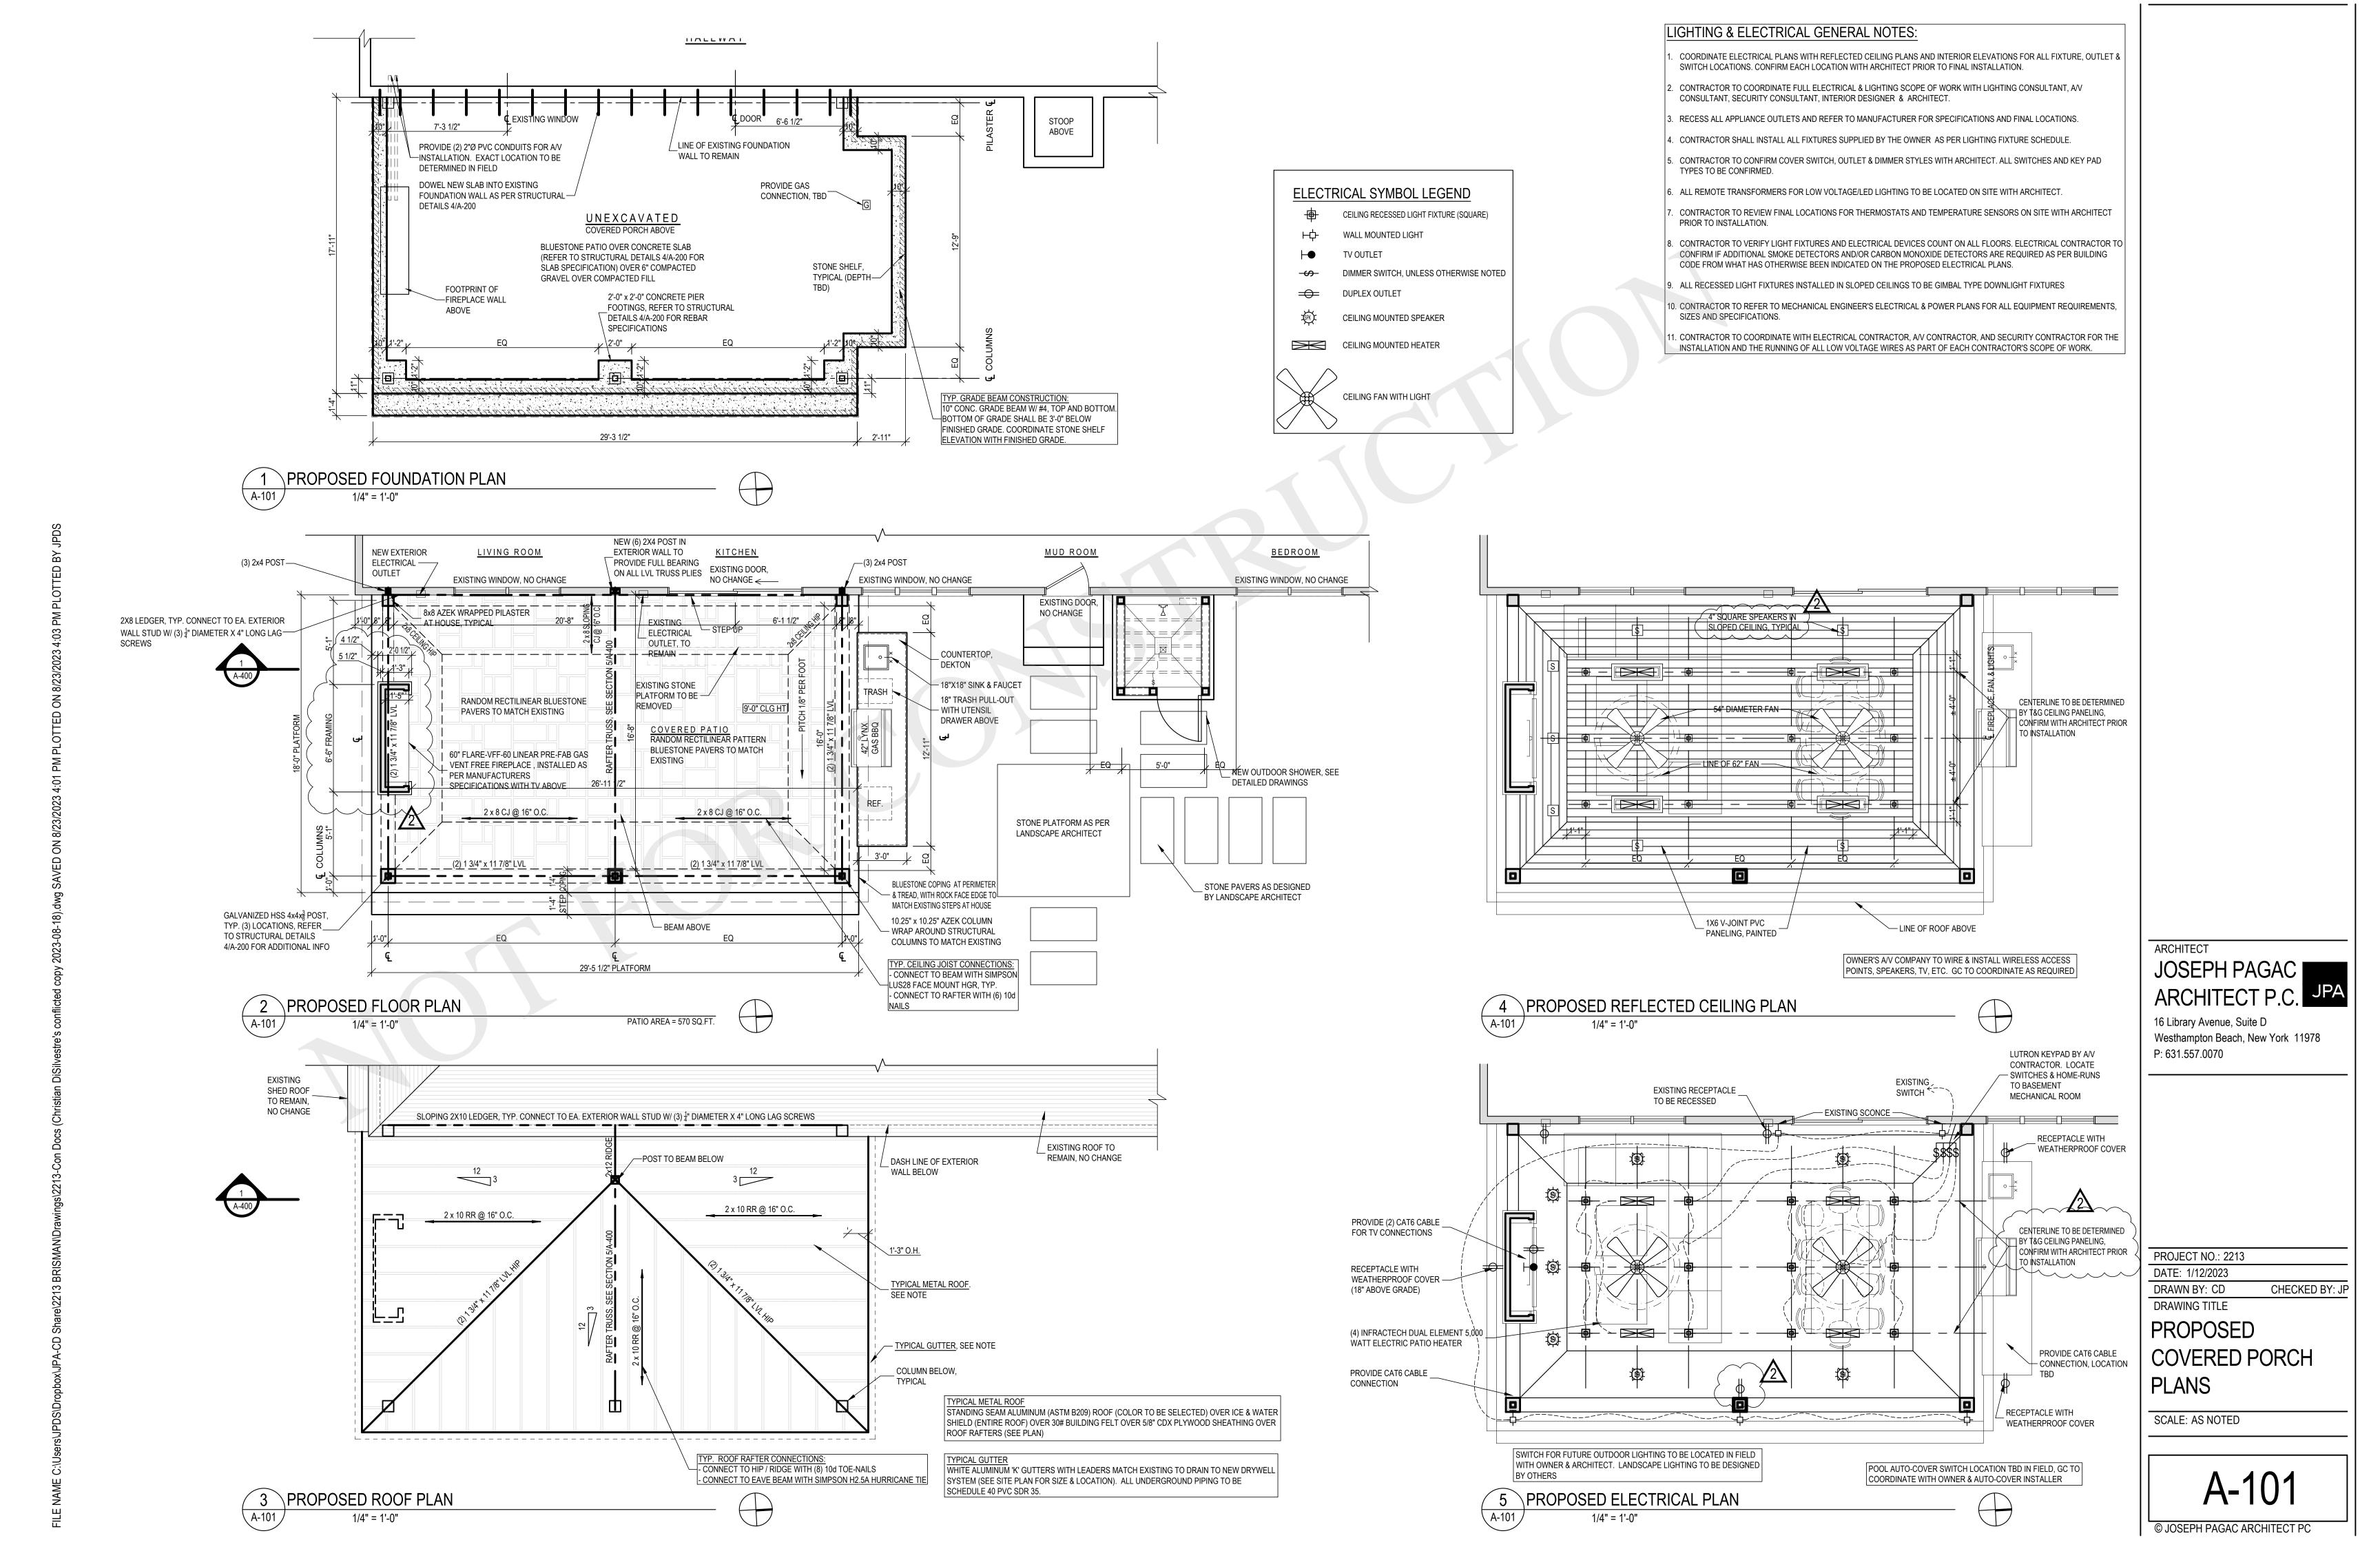

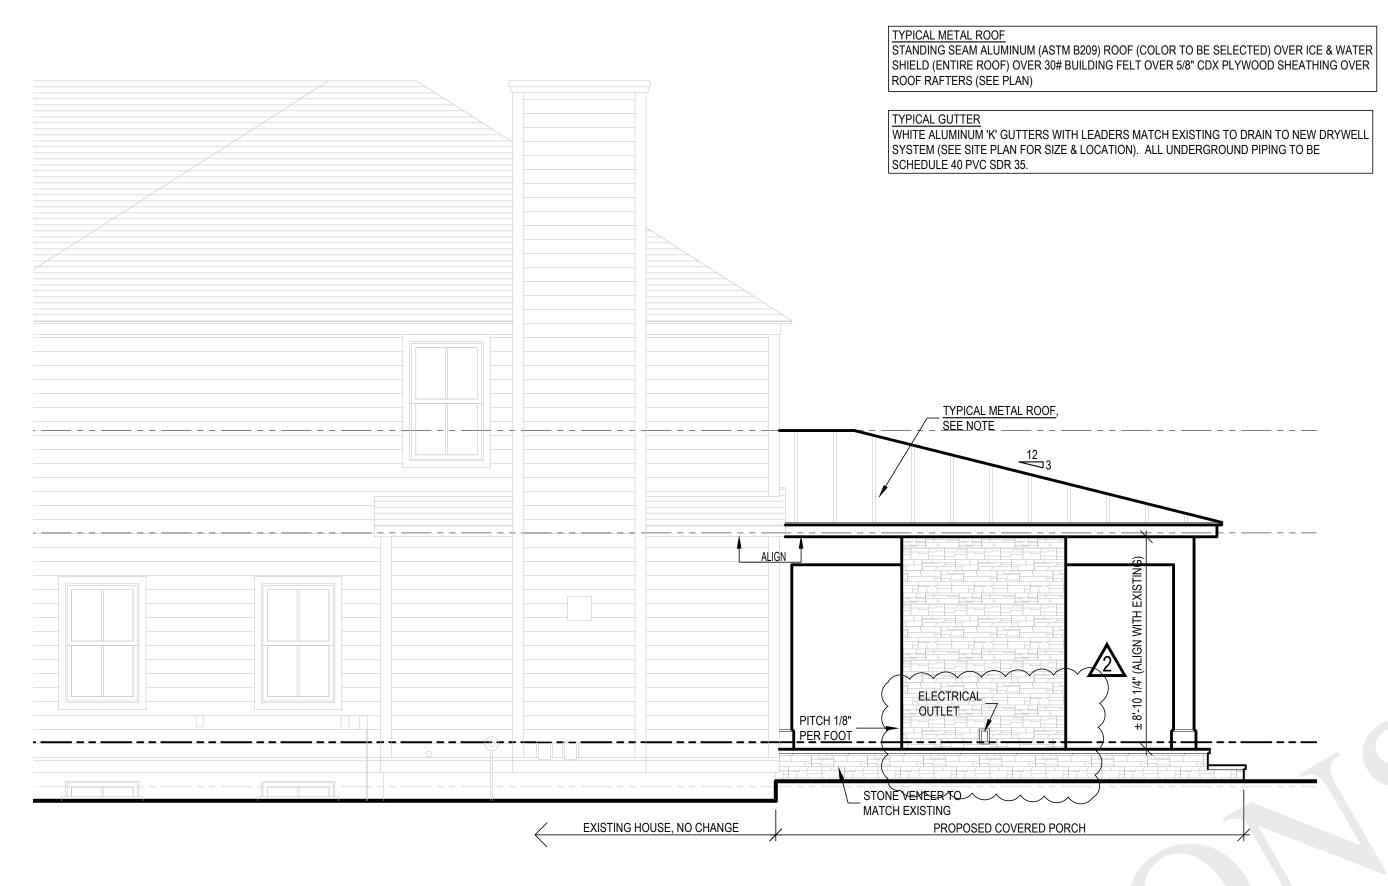



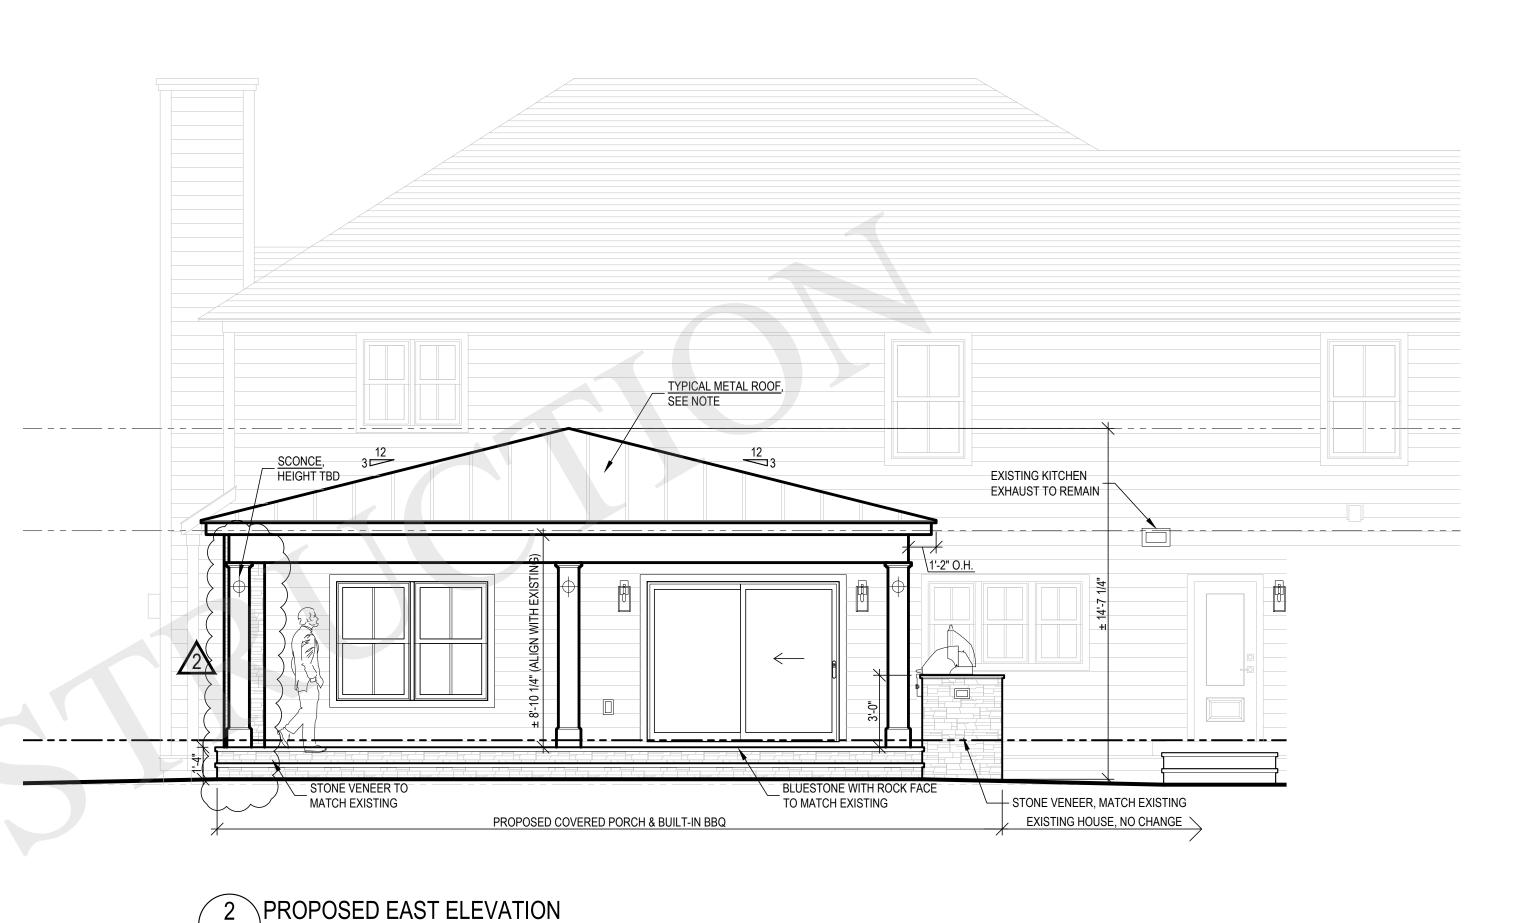

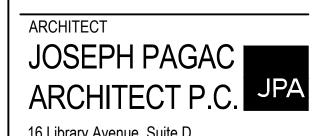

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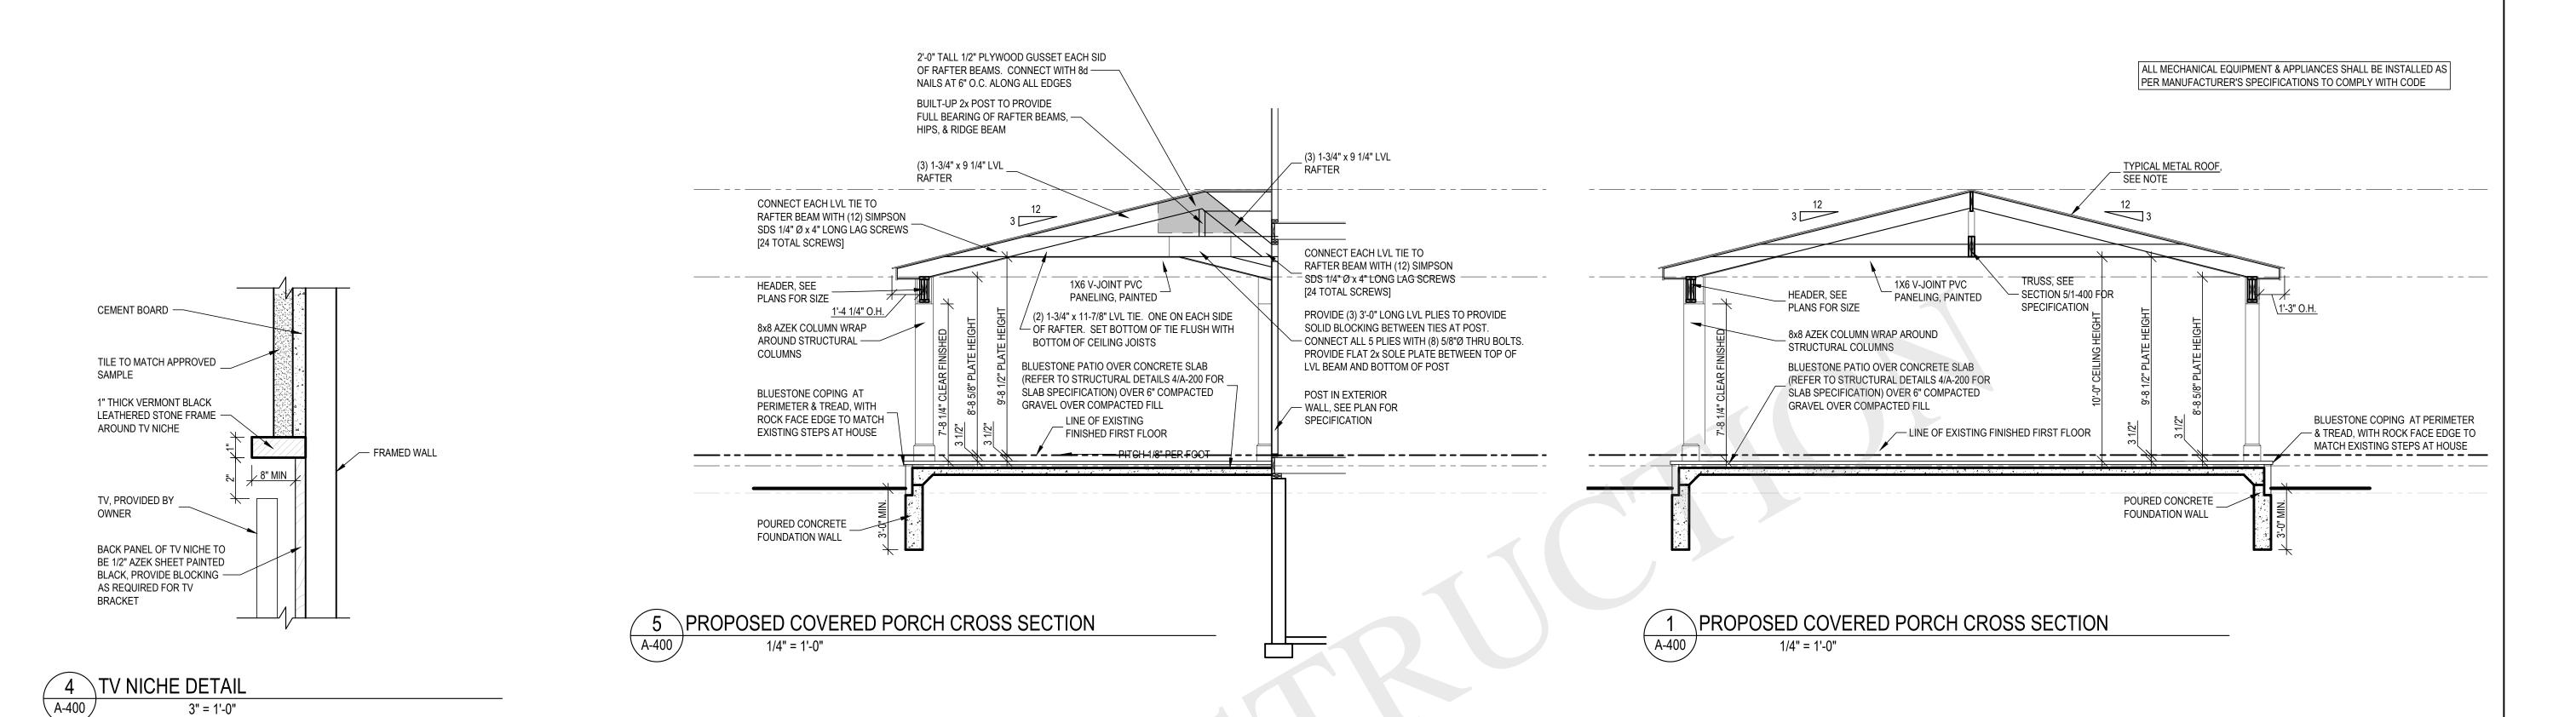
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PROPOSED EXTERIOR ELEVATIONS & DETAILS


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A-200

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TYPICAL 1X6 V-JOINT PVC PANELING, PAINTED 5'-1 3/4" FINISHED NICHE OPENING BACK PANEL OF TV NICHE TO BE 1/2" AZEK SHEET PAINTED TELEVISION, PROVIDED BY BLACK, PROVIDE BLOCKING AS OWNER. DEPTH OF TV NICHE REQUIRED FOR TV BRACKET $^{ ext{-}}$ TO BE 8". FACE OF TV TO BE -FLUSH WITH FACE OF STONE SURROUND 1" THICK VERMONT BLACK LEATHERED STONE FRAME AROUND TV NICHE TILE TO MATCH APPROVED DASHED LINE OF ROUGH SAMPLE OPENING FLARE-VFF-60 [24"H] VENT FREE GAS FIREPLACE INSTALLED AS PER MANUFACTURER'S 10.25" x 10.25" AZEK COLUMN SPECIFICATIONS PROVIDE CONCEALED ACCESS WRAP AROUND - PANEL ON SIDE WALL AS STRUCTURAL COLUMNS TO [PROVIDE CORROSION RESISTANT DRAIN PAN UNDER FIREPLACE AS PER MANUFACTURER] REQUIRED BY MANUFACTURER MATCH EXISTING 5/4 x 10 AZEK BASE -- LINE OF FINISHED STONE ± 6'-10" (FINISHED)



3 PROPOSED BBQ ELEVATION (SOUTH)
3/4" = 1'-0"

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PROPOSED CROSS
SECTION AND
INTERIOR ELEVATIONS

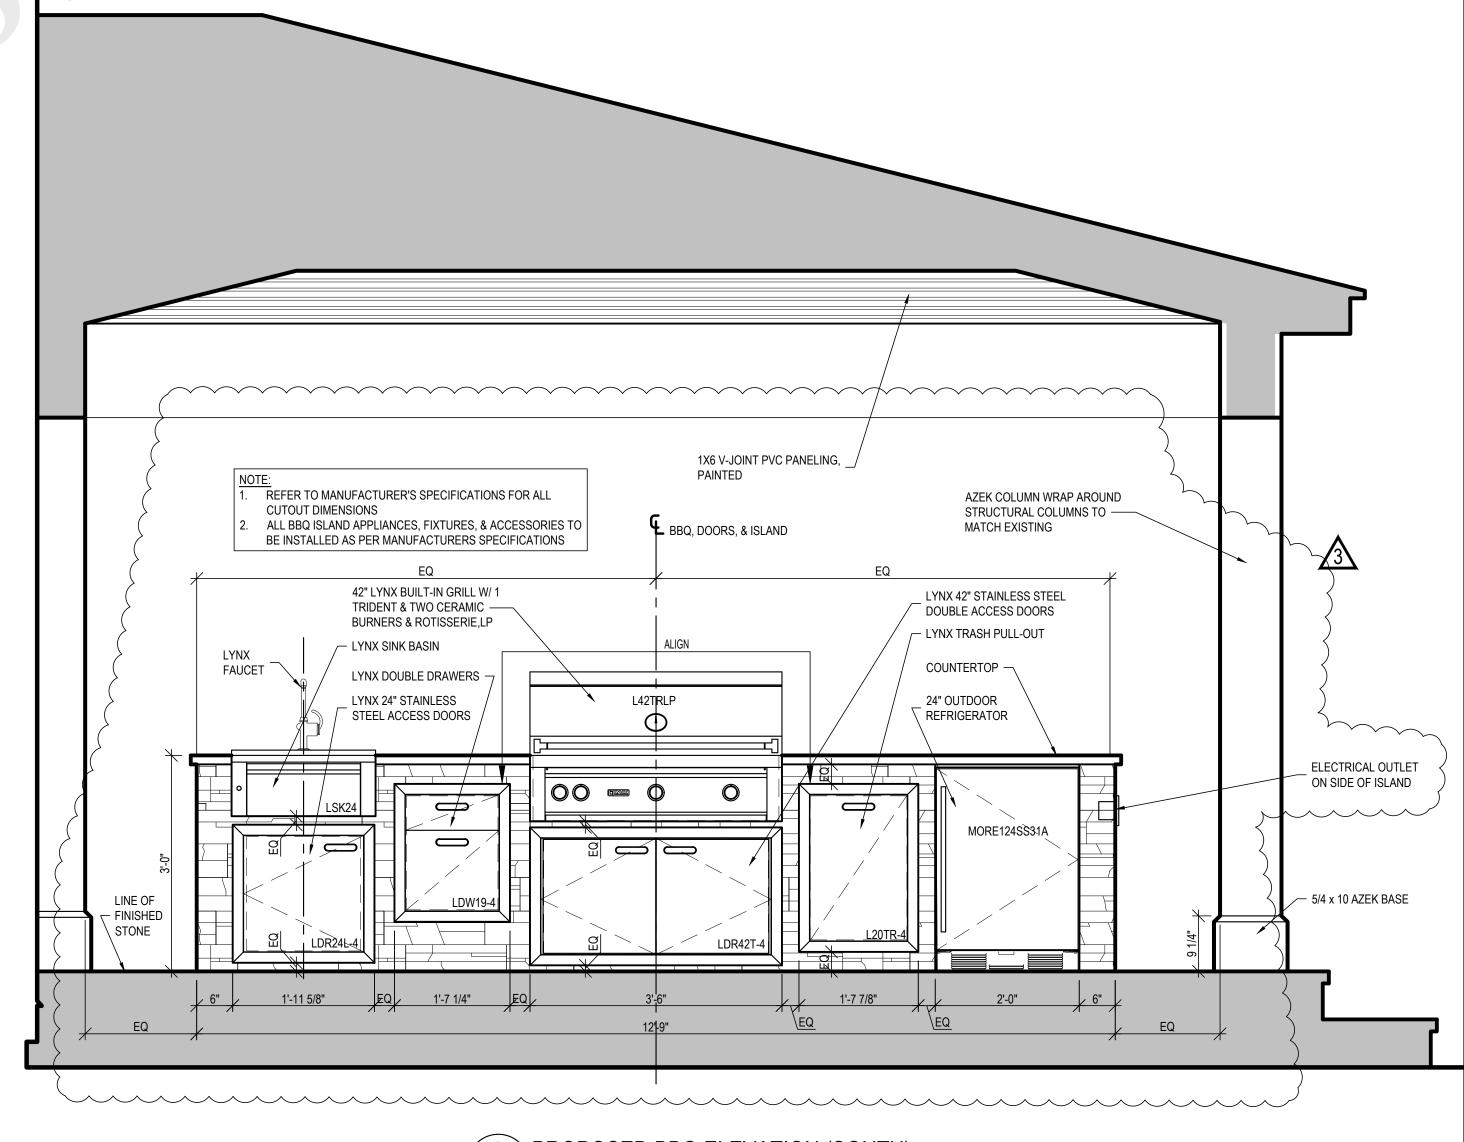
SCALE: AS NOTED

A-400


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PROPOSED FIREPLACE ELEVATION (NORTH)

3/4" = 1'-0"

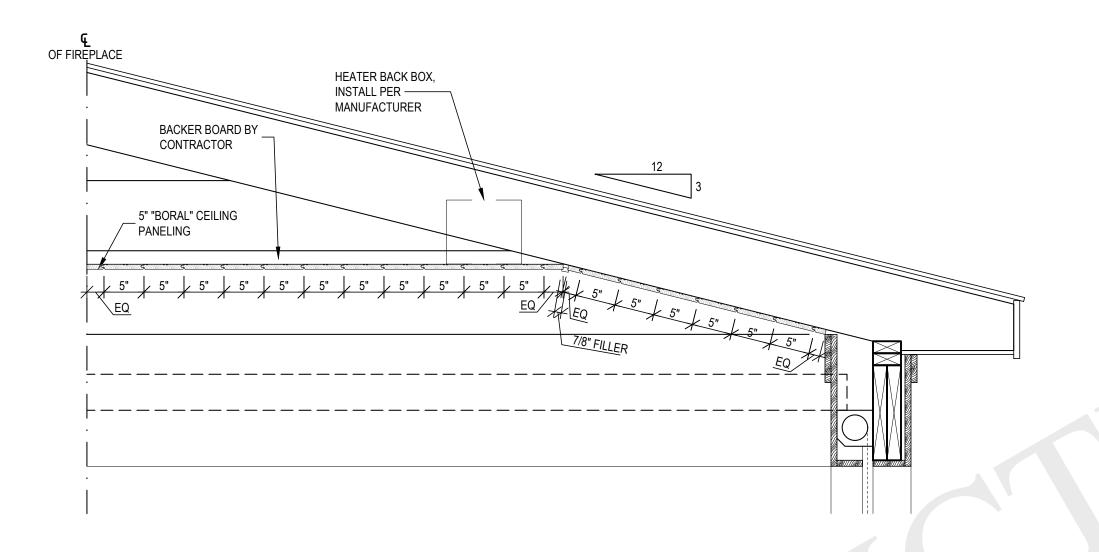

2 COVERED PORCH SECTION 1 1/2" = 1'-0"

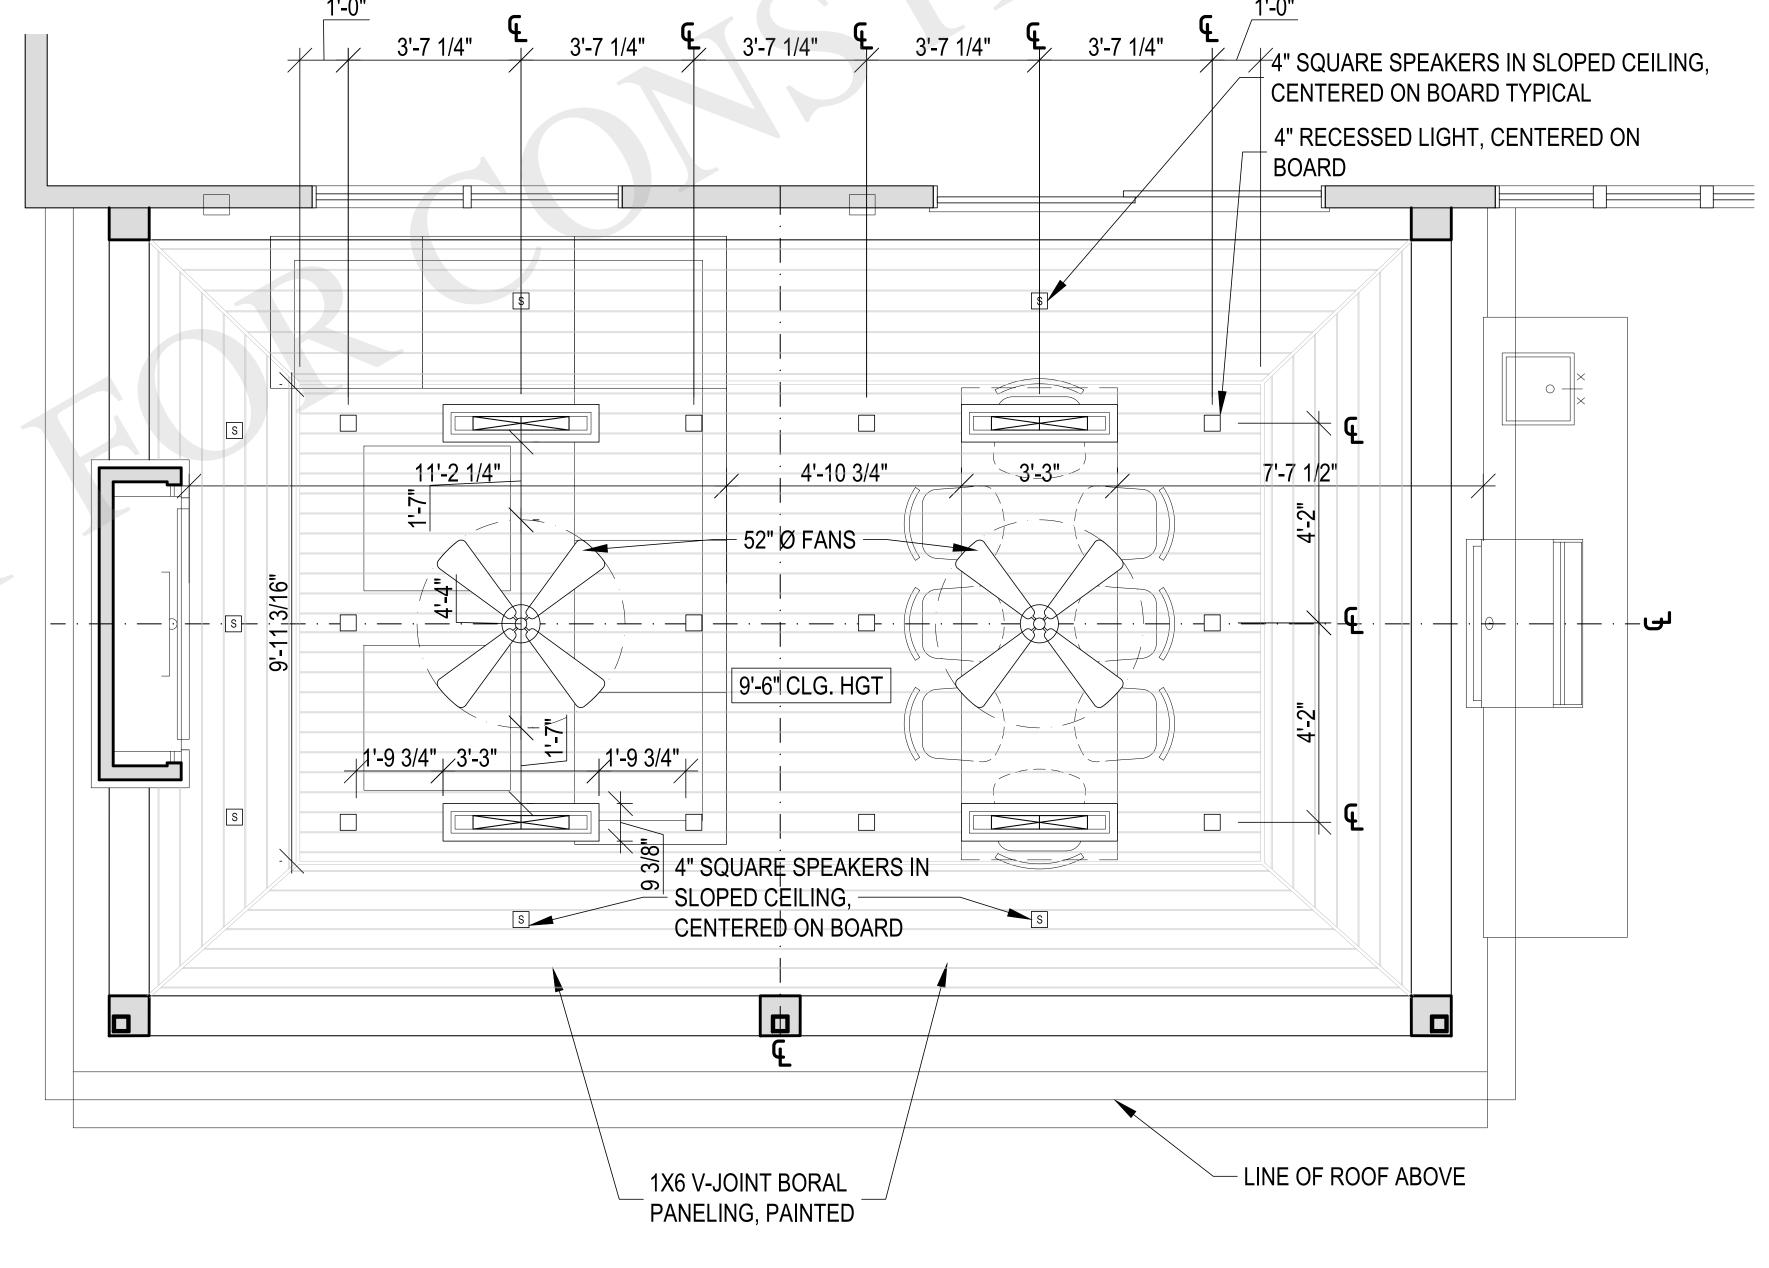

1 UPDATED REFLECTED CEILING PLAN
1/4" = 1'-0"



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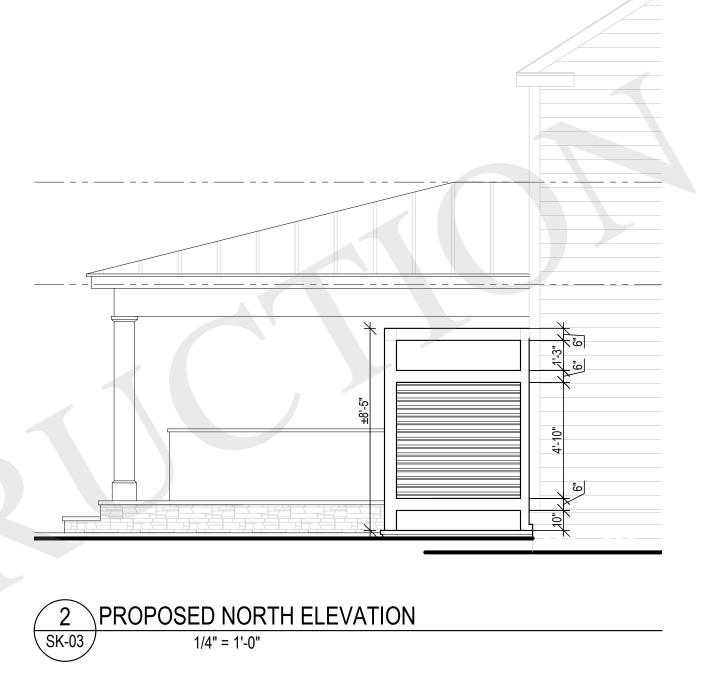
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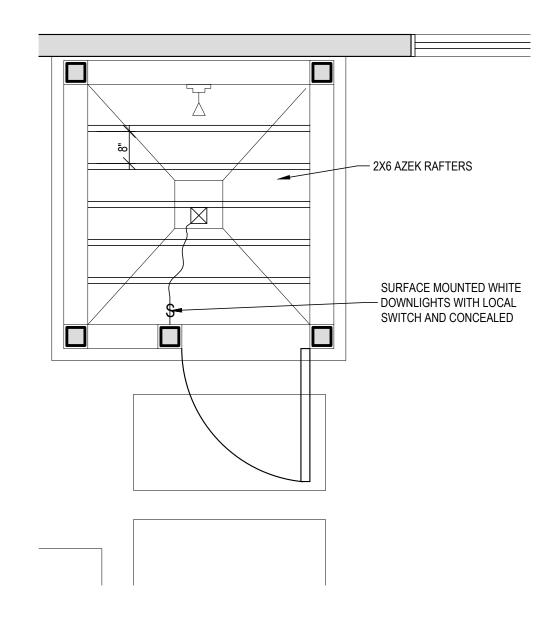
REFLECTED CEILING PLAN & DETAILS

SCALE: AS NOTED


SK-05

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3 PROPOSED OUTDOOR SHOWER RCP




4 PROPOSED OUTDOOR SHOWER PLAN

SK-03

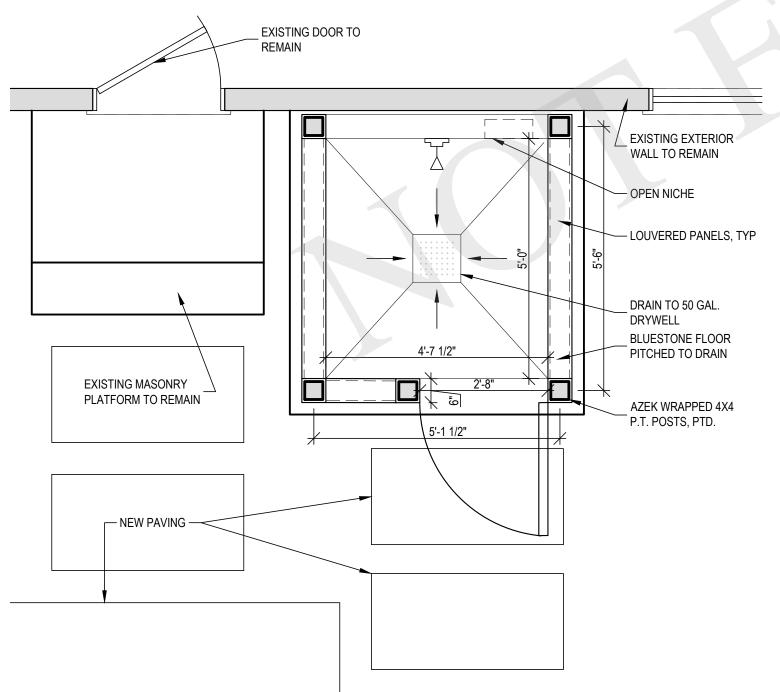





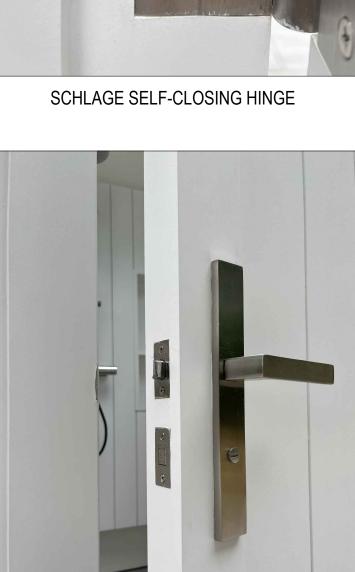

EMTEK HANDLE SET (EXTERIOR)

7 SAMPLE PHOTOS

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(4) 2X6 AZEK RAFTERS, PTD — 2X6 AZEK RAFTERS, PTD SCHLAGE SELF-CLOSING HINGE (3) SCHLAGE SELF-CLOSING
HINGES AS PER ATTACHED
PHOTO, PROVIDE CUT SHEET
FOR APPROVAL (SATIN NICKEL) — OPEN NICHE EMTEK HANDLESET AS PER
ATTACHED PHOTO, PROVIDE CUT
SHEET FOR APPROVAL (SATIN LOUVERED PANELS, TYP V-GROOVE CHANNEL (CHANNEL TO END 1" PLUMBING THROUGH
BOX BEAM CLEAR OF TOP & BOTTOM RAIL)

SK-03

6 PLUMBING WALL ELEVATION

1/2" = 1'-0"

5 OUTDOOR SHOWER ELEVATION
1/2" = 1'-0"

ARCHITECT JOSEPH PAGAC ARCHITECT P.C. JPA

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PROPOSED OUTDOOR SHOWER

SCALE: AS NOTED