

FRONT ELEVATION



REAR ELEVATION

ARCHITECT

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	AWING INDEX		
	AWING INDEX		PROJECT NO.: 2211
A-001	GENERAL CODE COMPLIANCE	1	DATE: 10/4/22
A-003	ENERGY CODE COMPLIANCE	1	DRAWN BY: CD
A-004	PLUMBING RISER DIAGRAM & NOTES	1	DRAWING TITLE
A-010	PROPOSED SITE PLAN	1	COVER SHE
A-100	PROPOSED FOUNDATION PLAN	1	

A-101 PROPOSED FIRST FLOOR PLAN

A-103 PROPOSED ROOF PLAN

A-102 PROPOSED SECOND FLOOR PLAN

A-200 PROPOSED EXTERIOR ELEVATIONS A-201 PROPOSED EXTERIOR ELEVATIONS

PROPOSED BUILDING SECTIONS

A-600 PROPOSED WINDOW TYPES & SCHEDULE

OVER SHEET

SCALE: AS NOTED



CHECKED BY: JP

- DECORATIVE FENCE

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DATE: 10/4/22 DRAWN BY: CD CHECKED BY: JP

DRAWING TITLE

PROPOSED LANDSCAPE PLAN

SCALE: AS NOTED

L-010

STORM DRAIN RINGS REQUIRED (VOLUME REQUIRED/168.9 CF) 6.63 RINGS REQ

REFER TO SITE PLAN FOR LOCATION OF DRYWELLS

168.9 CF


(1) 8'-0"Ø x 4'-0" H STORM DRAIN RING =

STORM DRAIN RINGS TO BE PROVIDED

SITE WORK NOTES:

- 1. COORDINATE ANY PLANTING AND LANDSCAPE REMOVAL WITH ARCHITECT AND OWNER PRIOR TO DISTURBING.
- 2. COORDINATE WORK FOR NEW UTILITY SERVICES AS REQUIRED WITH APPROPRIATE AGENCIES. MARK-OUT ALL SITE UTILITIES PRIOR TO REMOVALS.
- 3. CONFIRM LOCATIONS OF NEW TANKS WITH UTILITY COMPANY PRIOR TO
- 4. PROVIDE 42" HIGH SAFETY GUARDRAILS AROUND EXCAVATED AREAS AS REQUIRED BY LOCAL CODES.
- 5. COORDINATE WITH OWNER'S IRRIGATION COMPANY PRIOR TO REMOVALS AND AFTER FOR REPAIRS TO SYSTEM.
- 6. REFER TO PROJECT SPECIFICATIONS FOR ADDITIONAL INFO, AS APPLICABLE
- 7. REFER TO PROPERTY SURVEY, PREPARED BY OTHERS, FOR ADDITIONAL INFORMATION NOT SHOWN HERE
- 8. PROVIDE TEMPORARY FENCING AND RELATED WORK, AS REQUIRED BY BUILDING DEPARTMENT
- 9. REFER TO SHEET A-001 FOR ADDITIONAL NOTES, AS APPLICABLE.
- 10. EXISTING ADJACENT STRUCTURES SHALL BE ADEQUATELY SHORED, BRACED AND UNDERPINNED AS NECESSARY.

NYS CODE SECTION R326.4.2.8
DOORS WITH DIRECT ACCESS TO THE POOL THROUGH THAT WALL SHALL BE EQUIPPED WITH AN ALARM THAT PRODUCES AN AUDIBLE WARNING WHEN THE DOOR AND/OR ITS SCREEN, IF PRESENT, ARE OPENED. THE ALARM SHALL BE LISTED IN ACCORDANCE WITH UL 2017. THE AUDIBLE ALARM SHALL ACTIVATE WITHIN 7 SECONDS AND SOUND CONTINUOUSLY FOR A MINIMUM OF 30 SECONDS AFTER THE DOOR AND/OR ITS SCREEN, IF PRESENT, ARE OPENED AND BE CAPABLE OF BEING HEARD THROUGHOUT THE HOUSE DURING NORMAL HOUSEHOLD ACTIVITIES. THE ALARM SHALL AUTOMATICALLY RESET UNDER ALL CONDITIONS. THE ALARM SYSTEM SHALL BE EQUIPPED WITH A MANUAL MEANS, SUCH AS A TOUCH-PAD OR SWITCH, TO TEMPORARILY DEACTIVATE THE ALARM FOR A SINGLE OPENING. DEACTIVATION SHALL LAST FOR NOT MORE THAN 15 SECONDS. ANY DEACTIVATION SWITCH(ES) SHALL BE LOCATED AT LEAST 54" ABOVE THE THRESHOLD OF THE DOOR. OPERABLE WINDOWS IN THE WALL OR WALLS USED AS A BARRIER SHALL HAVE A LATCHING DEVICE LOCATED NO LESS THAN 48" ABOVE THE FLOOR. OPENINGS IN OPERABLE WINDOWS SHALL NOT ALLOW A 4-INCH DIAMETER SPHERE TO PASS THROUGH THE OPENING WHEN THE WINDOW IS IN ITS LARGEST OPENED POSITION.

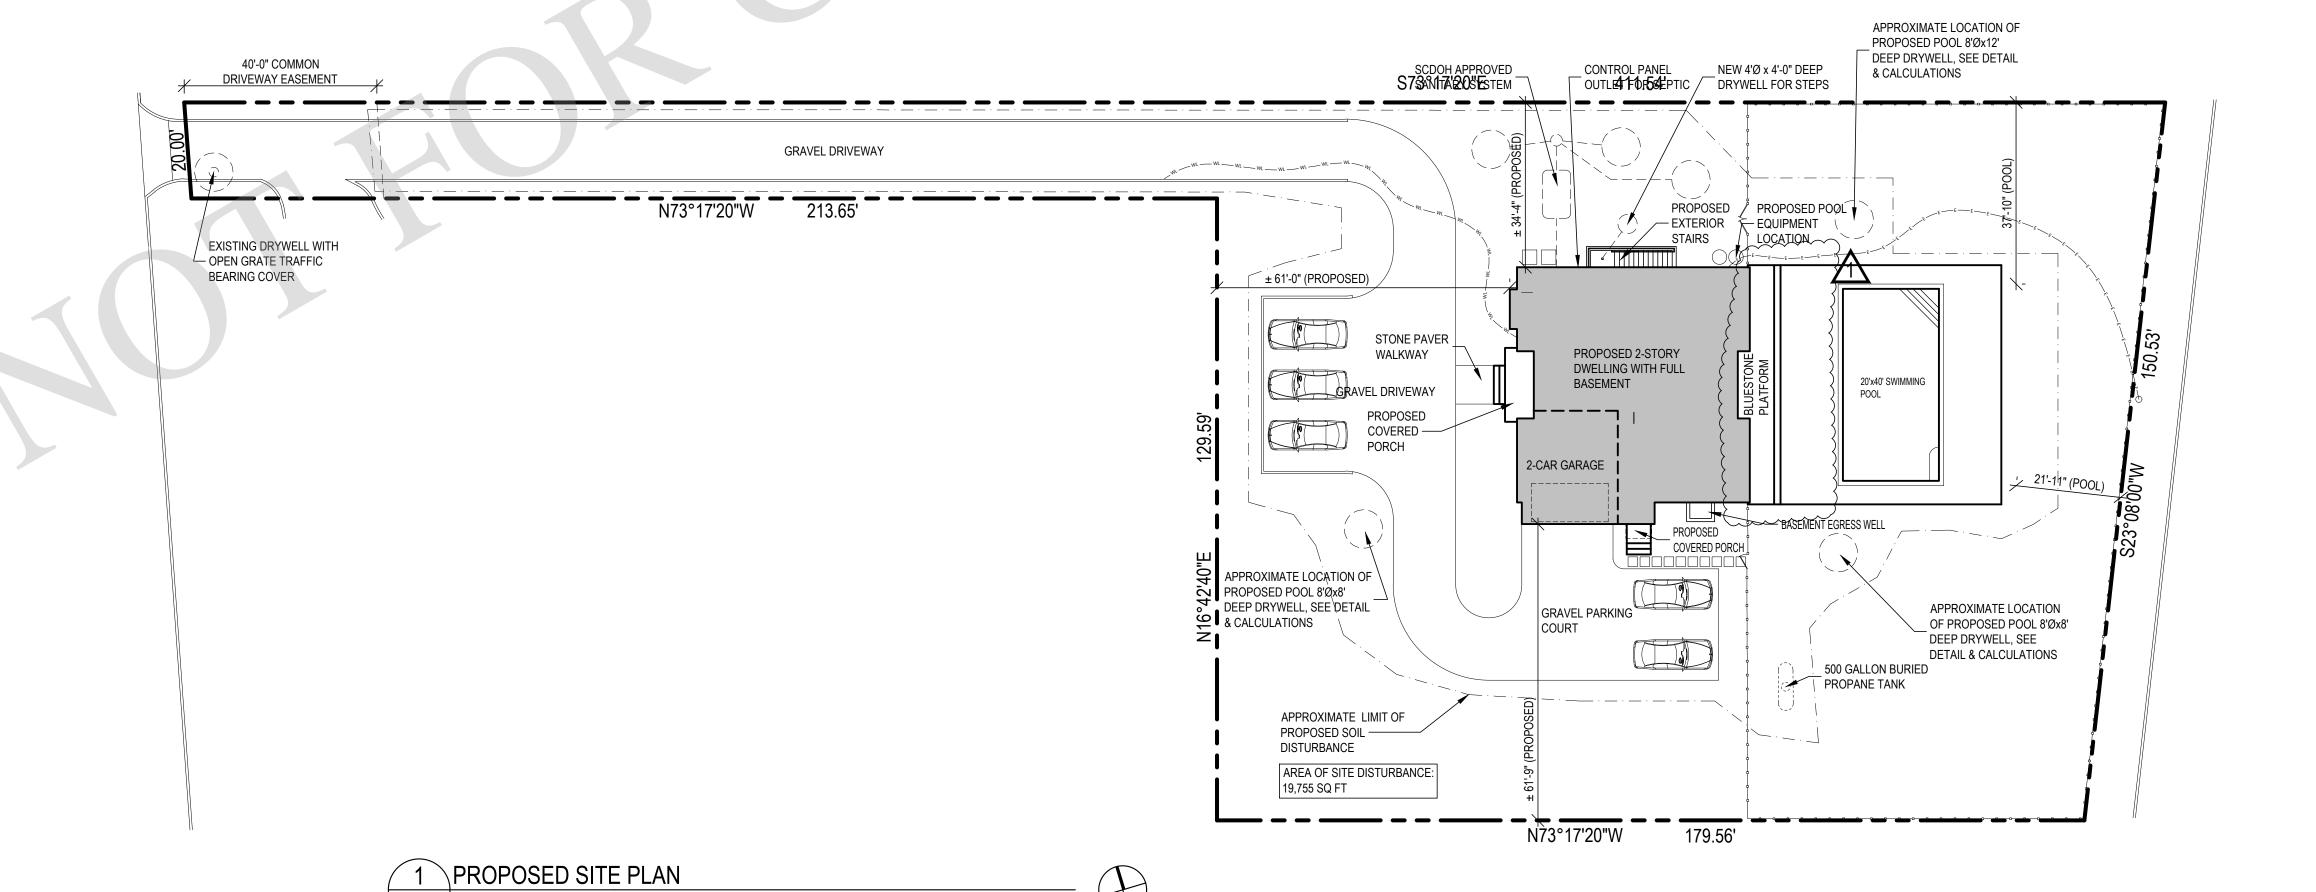

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DRAWING TITLE

PROPOSED SITE **PLAN**

SCALE: AS NOTED

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PROPOSED

FOUNDATION PLAN

SCALE: AS NOTED

A-100

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FLOOR PLAN

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DRAWING TITLE

PROPOSED SECOND FLOOR PLAN

SCALE: AS NOTED

TYPICAL ASPHALT ROOF

NEW ASPHALT ROOFING TO BE "GAF TIMBERLINE" 'LIFETIME HIGH DEFINITION SHINGLES', COLOR TO BE "SLATE" (SUBMIT SAMPLE FOR APPROVAL) OVER 30 # BUILDING FELT OVER 1/2" CDX PLYWOOD SHEATHING OVER ROOF RAFTERS (SEE PLAN). INSTALL ICE & WATER SHIELD FROM THE EAVES EDGE TO A POINT AT LEAST 2'-0" INSIDE THE EXTERIOR WALL LINE AND AT ALL VALLEYS, HIPS, & AS INDICATED ON ROOF PLAN AND AS REQUIRED TO MEET CODE. WEAVE IN ALL VALLEY'S TO CONCEAL FLASHING.

TYPICAL EXTERIOR WALL - CEDAR SIDING

NEW 'MAIBEC' CEDAR SHINGLES (SEE SPECS) OVER 'CEDAR BREATHER' (BENJAMIN OBDYKE) OVER 1/2" RIGID INSULATION BOARD (R-3) OVER #30 BUILDING FELT OVER 1/2" 'CDX' PLYWOOD SHEATHING OVER 2" X 6" STUD WALL. FILL WITH R-21 BATT INSULATION AND FINISH WITH 4 MIL

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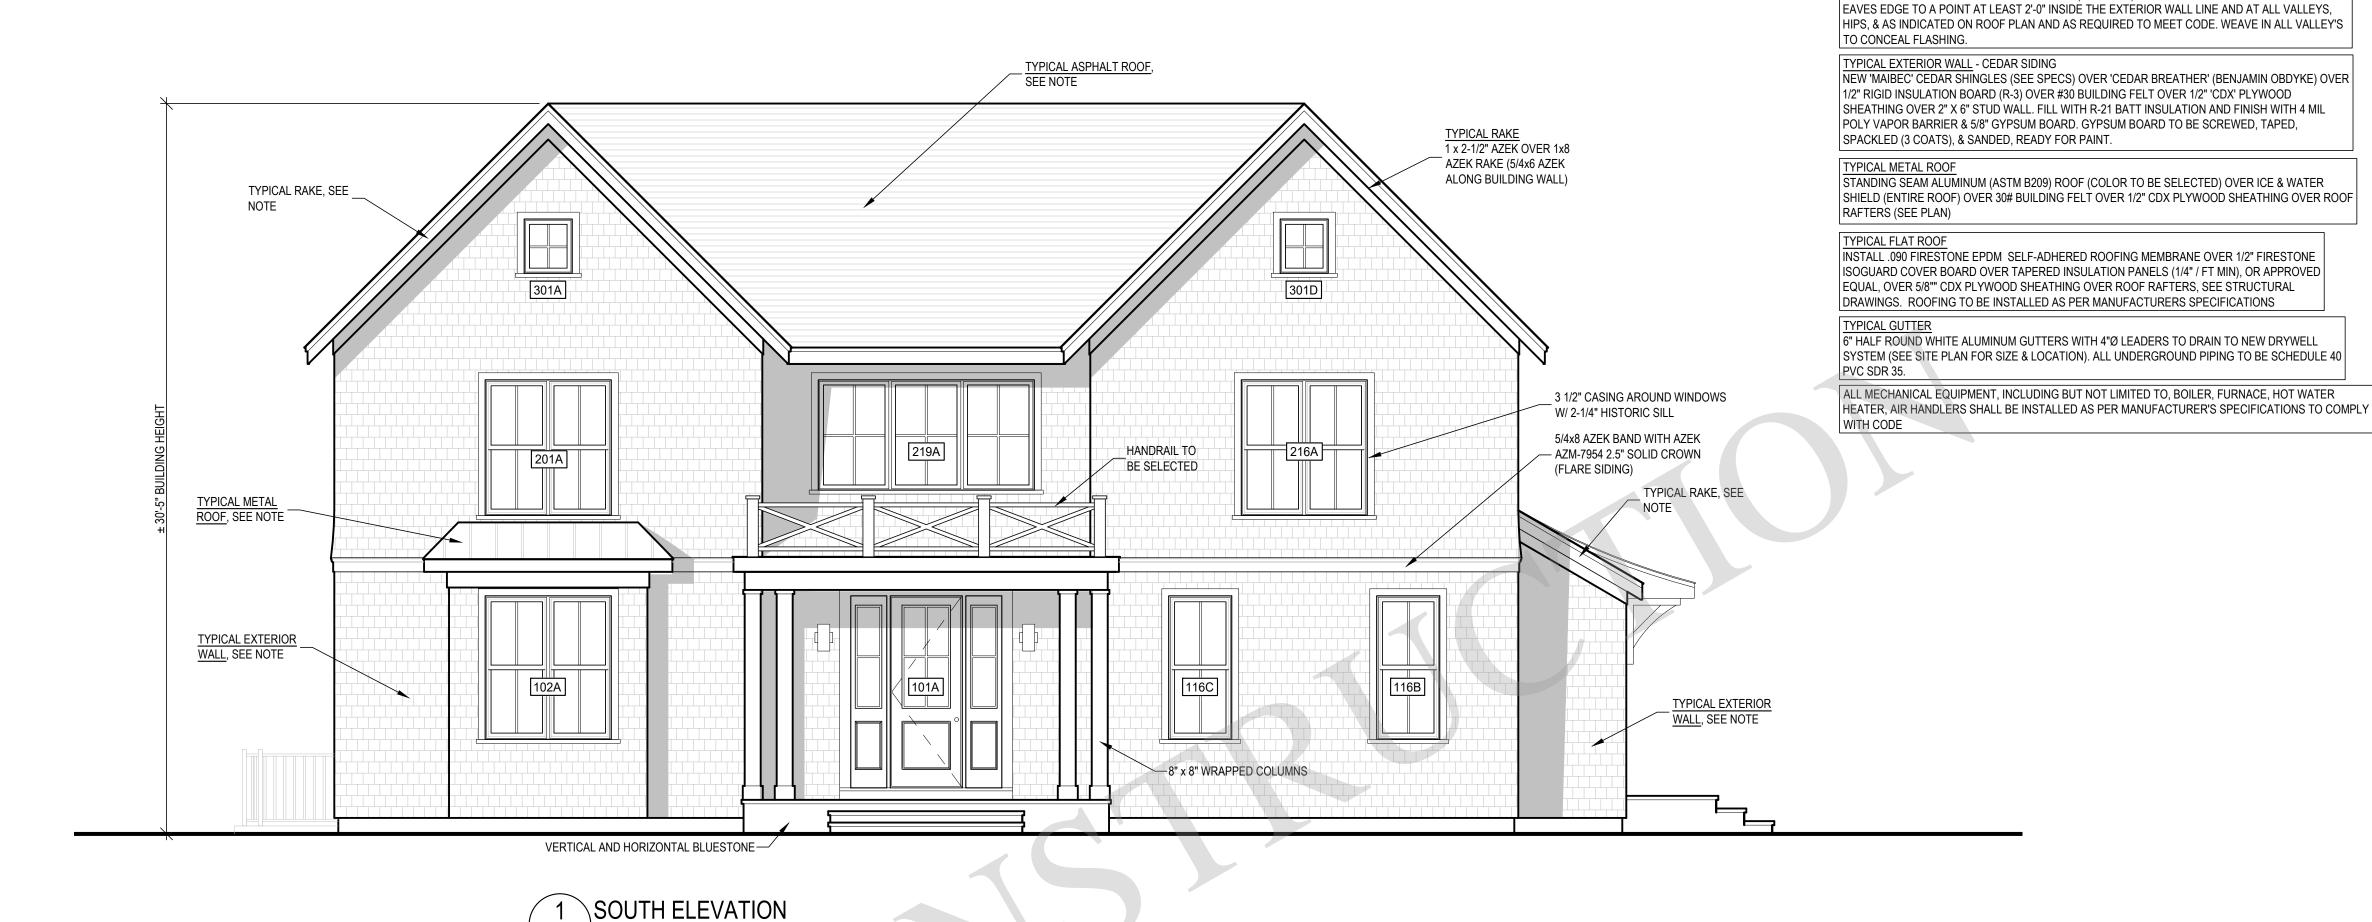
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PROPOSED ROOF PLAN

CHECKED BY: JP

SCALE: AS NOTED





SEAL

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TYPICAL ASPHALT ROOF
NEW ASPHALT ROOFING TO BE "GAF TIMBERLINE" 'LIFETIME HIGH DEFINITION SHINGLES', COLOR

TO BE "SLATE" (SUBMIT SAMPLE FOR APPROVAL) OVER 30 # BUILDING FELT OVER 1/2" CDX PLYWOOD SHEATHING OVER ROOF RAFTERS (SEE PLAN). INSTALL ICE & WATER SHIELD FROM THE

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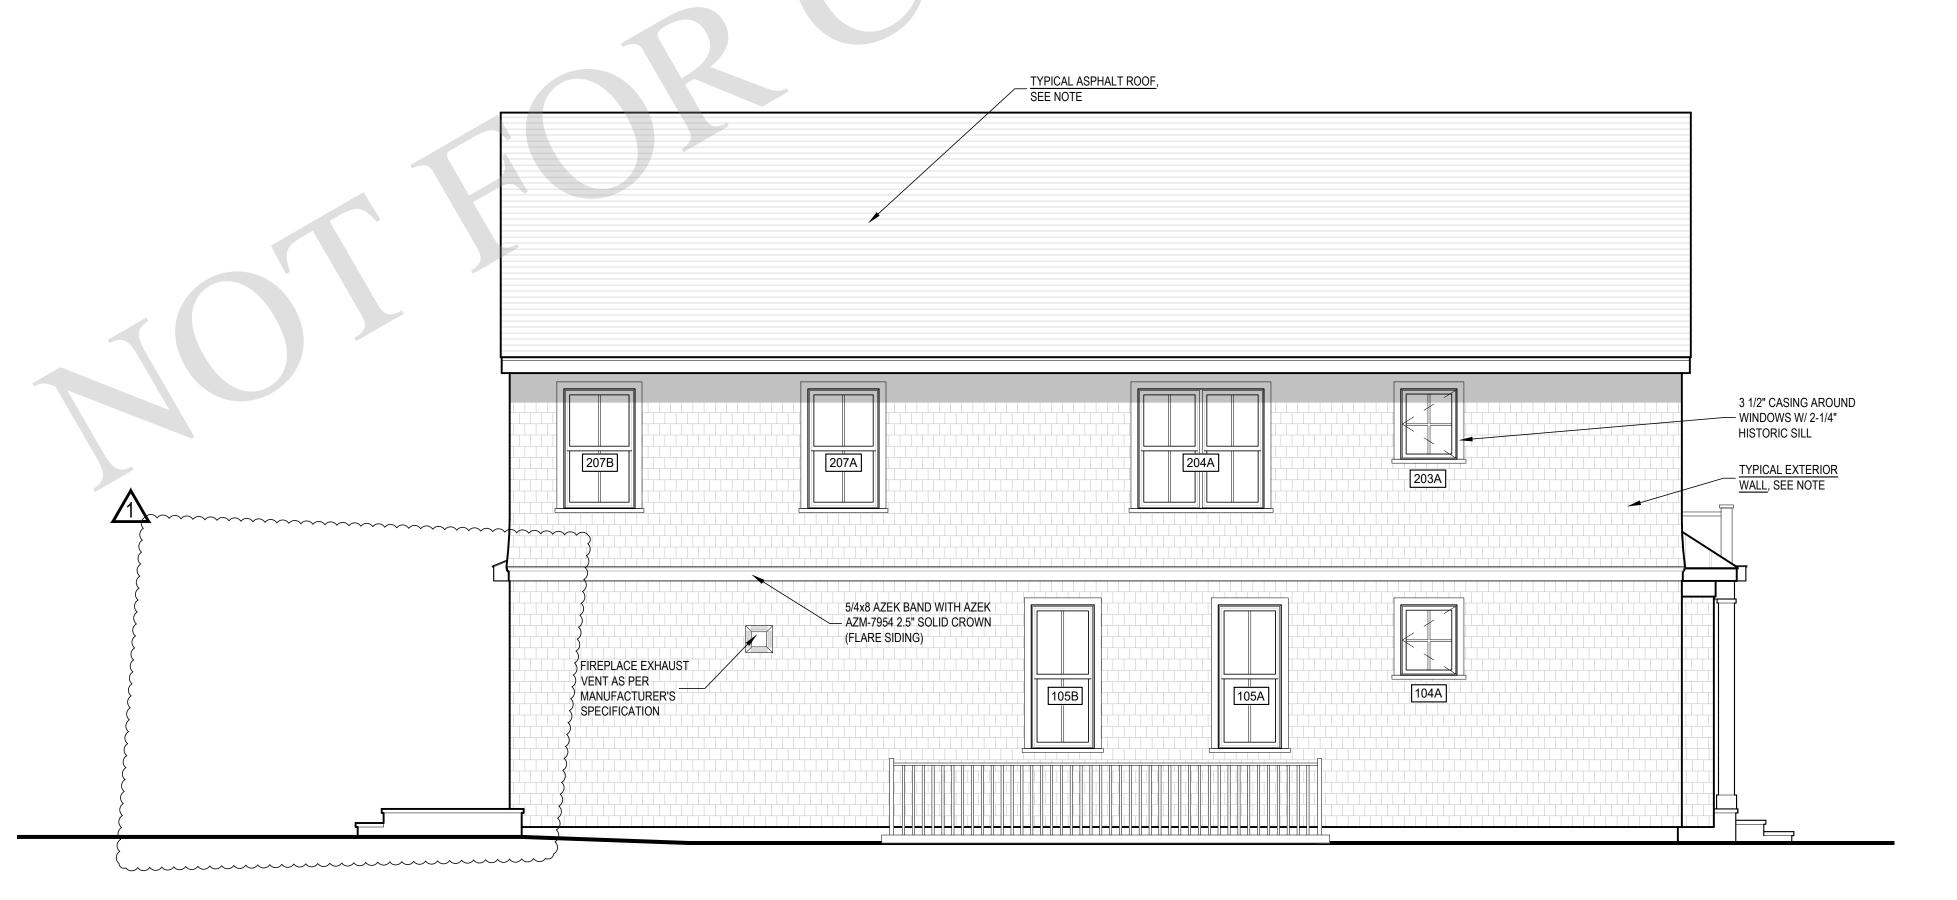
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DRAWING TITLE

PROPOSED EXTERIOR ELEVATIONS

SCALE: AS NOTED

A-200





\WESTELEVATION

TYPICAL ASPHALT ROOF
NEW ASPHALT ROOFING TO BE "GAF TIMBERLINE" 'LIFETIME HIGH DEFINITION SHINGLES', COLOR TO BE "SLATE" (SUBMIT SAMPLE FOR APPROVAL) OVER 30 # BUILDING FELT OVER 1/2" CDX PLYWOOD SHEATHING OVER ROOF RAFTERS (SEE PLAN). INSTALL ICE & WATER SHIELD FROM THE EAVES EDGE TO A POINT AT LEAST 2'-0" INSIDE THE EXTÉRIOR WALL LINE AND AT ALL VALLEYS, HIPS, & AS INDICATED ON ROOF PLAN AND AS REQUIRED TO MEET CODE. WEAVE IN ALL VALLEY'S TO CONCEAL FLASHING.

TYPICAL EXTERIOR WALL - CEDAR SIDING

NEW 'MAIBEC' CEDAR SHINGLES (SEE SPECS) OVER 'CEDAR BREATHER' (BENJAMIN OBDYKE) OVER 1/2" RIGID INSULATION BOARD (R-3) OVER #30 BUILDING FELT OVER 1/2" 'CDX' PLYWOOD SHEATHING OVER 2" X 6" STUD WALL. FILL WITH R-21 BATT INSULATION AND FINISH WITH 4 MIL POLY VAPOR BARRIER & 5/8" GYPSUM BOARD. GYPSUM BOARD TO BE SCREWED, TAPED, SPACKLED (3 COATS), & SANDED, READY FOR PAINT.


STANDING SEAM ALUMINUM (ASTM B209) ROOF (COLOR TO BE SELECTED) OVER ICE & WATER SHIELD (ENTIRE ROOF) OVER 30# BUILDING FELT OVER 1/2" CDX PLYWOOD SHEATHING OVER ROOF RAFTERS (SEE PLAN)

TYPICAL METAL ROOF

TYPICAL FLAT ROOF
INSTALL .090 FIRESTONE EPDM SELF-ADHERED ROOFING MEMBRANE OVER 1/2" FIRESTONE
INSTALL .090 FIRESTONE EPDM SELF-ADHERED ROOFING MEMBRANE OVER 1/2" FIRESTONE
INSTALL .090 FIRESTONE EPDM SELF-ADHERED ROOFING MEMBRANE OVER 1/2" FIRESTONE
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INSTALL .090 FIRESTONE EPDM SELF-ADHERED ROOFING MEMBRANE OVER 1/2" FIRESTONE ISOGUARD COVER BOARD OVER TAPERED INSULATION PANELS (1/4" / FT MIN), OR APPROVED EQUAL, OVER 5/8"" CDX PLYWOOD SHEATHING OVER ROOF RAFTERS, SEE STRUCTURAL DRAWINGS. ROOFING TO BE INSTALLED AS PER MANUFACTURERS SPECIFICATIONS

TYPICAL GUTTER
6" HALF ROUND WHITE ALUMINUM GUTTERS WITH 4"Ø LEADERS TO DRAIN TO NEW DRYWELL SYSTEM (SEE SITE PLAN FOR SIZE & LOCATION). ALL UNDERGROUND PIPING TO BE SCHEDULE 40 PVC SDR 35.

ALL MECHANICAL EQUIPMENT, INCLUDING BUT NOT LIMITED TO, BOILER, FURNACE, HOT WATER HEATER, AIR HANDLERS SHALL BE INSTALLED AS PER MANUFACTURER'S SPECIFICATIONS TO COMPLY WITH CODE

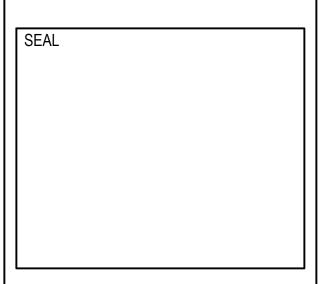

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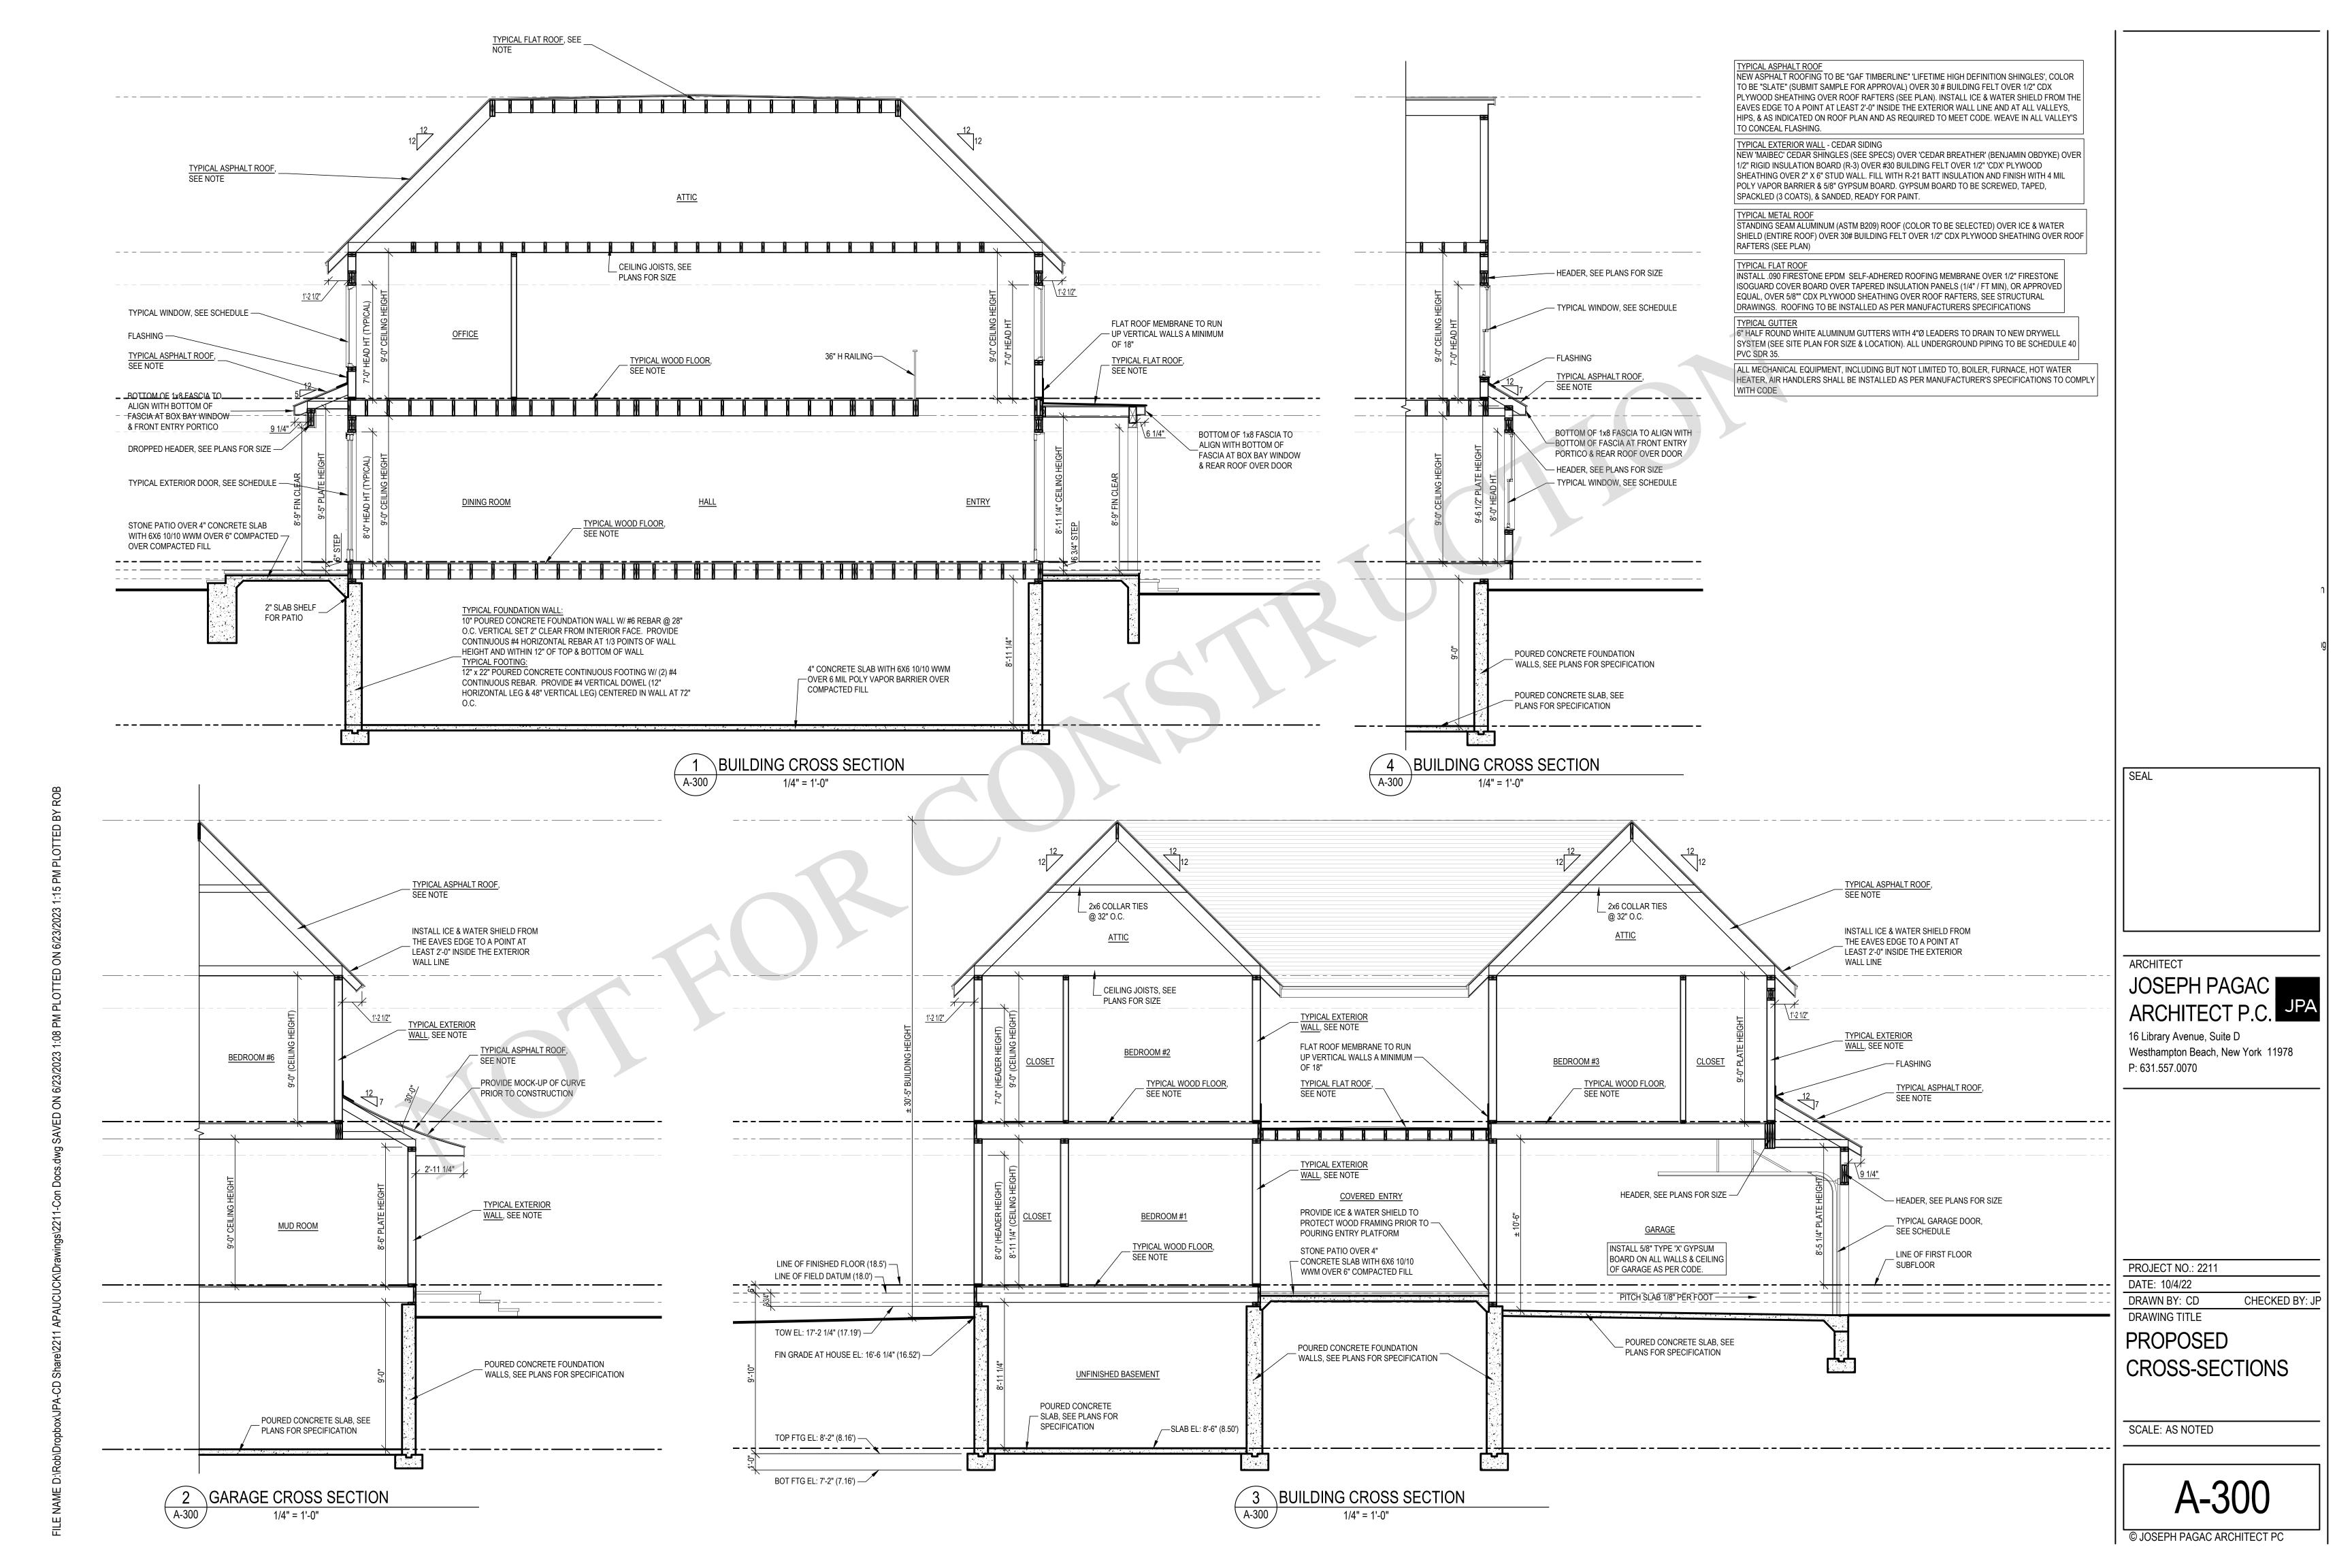
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DRAWING TITLE PROPOSED

EXTERIOR **ELEVATIONS**

SCALE: AS NOTED





	WINDOW	& E	6/23/2023				
UNIT	LOCATION	TYPE	SIZE (APPROXIMATE)	MANUFACTURER	STYLE	MODEL#	NOTES
101A	ENTRY	Α	7'-3 x 8'-0"	TBD	EXTERIOR DOOR	TBD	36" DOOR & (2) 24" SIDE LIGHTS
102A	BEDROOM #1	F	5'-7" x 6'-0"	ANDERSEN	(2) DOUBLE HUNGS	TW228510	3" SUPPORT MULLION
104A	BATH #1	К	2'-7" x 3'-0"	ANDERSEN	AWNING	AXW281	TEMPERED GLAZING
105A	STUDY ROOM	Е	3'-0" x 6'-0"	ANDERSEN	DOUBLE-HUNG	TW210510	
105B	STUDY ROOM	Е	3'-0" x 6'-0"	ANDERSEN	DOUBLE-HUNG	TW210510	
106A	LIVING ROOM	D	11'-9" x 8'-0"	ANDERSEN	SLIDING GLASS DOORS	FWG12080	QUAD SLIDER
108A	LIVING ROOM	D	11'-9" x 8'-0"	ANDERSEN	SLIDING GLASS DOORS	FWG12080	QUAD SLIDER
109A	KITCHEN	0	9'-0" x 4'-5"	ANDERSEN	(3) CASEMENTS	CXW145	
109B	KITCHEN	М	3'-0" x 4'-5"	ANDERSEN	CASEMENT	CXW145	
109C	KITCHEN	М	3'-0" x 4'-5"	ANDERSEN	CASEMENT	CXW145	
110A	MUD ROOM	В	3'-0" x 7'-0"	TBD	EXTERIOR DOOR	TBD	
116A	GARAGE	С	16'-0" x 8'-0"	TBD	OVERHEAD GARAGE DOOR	TBD	
116B	GARAGE	E	3'-0" x 6'-0"	ANDERSEN	DOUBLE-HUNG	TW210510	
116C	GARAGE	E	3'-0" x 6'-0"	ANDERSEN	DOUBLE-HUNG	TW210510	

	WINDOW	& EX	TERIOR DOOR SCHEDULE - SECOND FLOOR			6/23/2023	
TINU	LOCATION	TYPE	SIZE (APPROXIMATE)	MANUFACTURER	STYLE	MODEL#	NOTES
201A	BEDROOM #3	N	5'-7" x 5'-5"	ANDERSEN	(2) DOUBLE HUNGS	TW2852	3" SUPPORT MULLION
203A	BATH #3	К	2'-7" x 3'-0"	ANDERSEN	AWNING	AXW281	TEMPERED GLAZING
204A	PRIMARY BATH #4	Н	6'-0" x 5'-1"	ANDERSEN	(2) DOUBLE HUNGS	TW210410	3" SUPPORT MULLION / TEMPERED GLAZING
207A	PRIMARY BEDROOM #4	G	3'-0" x 5'-0"	ANDERSEN	DOUBLE-HUNG	TW210410	
207B	PRIMARY BEDROOM #4	G	3'-0" x 5'-0"	ANDERSEN	DOUBLE-HUNG	TW210410	
207C	PRIMARY BEDROOM #4	I	8'-11" x 5'-1"	ANDERSEN	(3) DOUBLE-HUNG	TW210410	3" SUPPORT MULLION
208A	OFFICE		8'-11" x 5'-1"	ANDERSEN	(3) DOUBLE-HUNG	TW210410	3" SUPPORT MULLION
209A	BEDROOM #5	G	3'-0" x 5'-0"	ANDERSEN	DOUBLE-HUNG	TW210410	
209B	BEDROOM #5	G	3'-0" x 5'-0"	ANDERSEN	DOUBLE-HUNG	TW210410	
209C	BEDROOM #5	Н	6'-0" x 5'-1"	ANDERSEN	(2) DOUBLE HUNGS	TW210410	3" SUPPORT MULLION
210A	BATH #5	G	3'-0" x 5'-0"	ANDERSEN	DOUBLE-HUNG	TW210410	TEMPERED GLAZING
213A	BEDROOM #6	Н	6'-0" x 5'-1"	ANDERSEN	(2) DOUBLE HUNGS	TW210410	3" SUPPORT MULLION
217A	BATH #2	К	2'-7" x 3'-0"	ANDERSEN	AWNING	AXW281	TEMPERED GLAZING
216A	BEDROOM #2	N	5'-7" x 5'-5"	ANDERSEN	(2) DOUBLE HUNGS	TW2852	3" SUPPORT MULLION
219A	UPPER HALL / LANDING	J	9'-0" x 4'-5"	ANDERSEN	CASEMENT	CXW145	3" SUPPORT MULLION

	WIND	OW	6/23/2023				
UNIT	LOCATION	TYPE	SIZE (APPROXIMATE)	MANUFACTURER	STYLE	MODEL#	NOTES
301A	ATTIC	L	2'-0" x 2'-4"	ANDERSEN	CASEMENT	C125	FIXED
301B	ATTIC	L	2'-0" x 2'-4"	ANDERSEN	CASEMENT	C125	FIXED
301C	ATTIC	L	2'-0" x 2'-4"	ANDERSEN	CASEMENT	C125	FIXED
301D	ATTIC	L	2'-0" x 2'-4"	ANDERSEN	CASEMENT	C125	FIXED

EXTERIOR DOOR & WINDOW GENERAL NOTES:

A-600

- 1 WINDOWS TO BE "ANDERSEN" ' 400 SERIES'. ALL GLAZING TO BE HIGH-PERFORMANCE LOW-E4. FULL DIVIDED LITE WITH SPACER TOP/BOTTOM. 7/8" MUNTIN BAR DIVISIONS AS PER ELEVATIONS 2 DOORS TO BE "ANDERSEN" ' 400 SERIES'. ALL GLAZING TO BE HIGH-PERFORMANCE LOW-E4. FULL DIVIDED LITE WITH SPACER TOP/BOTTOM. 7/8" MUNTIN BAR DIVISIONS AS PER ELEVATIONS
- 3 ALL WINDOWS TO HAVE WHITE HARDWARE & DOORS TO HAVE BRIGHT BRASS HARDWARE


EXTERIOR DOOR & WINDOW SCHEDULE


3 EXTERIOR WINDOW TYPES

A-600

- 4 ALL CLAD DOORS AND WINDOWS TO BE WHITE. ALL SCREENS IN WINDOWS TO "TRUSCENE" (WHITE) & DOORS TO RECEIVE STANDARD MESH (WHITE). PRICE TO INCLUDE SCREENS FOR ALL FRENCH DOORS
- 5 HEIGHTS AND WIDTHS LISTED ABOVE ARE APPROXIMATE AND ARE NOT TO BE USED FOR FRAMING ROUGH OPENINGS. CONFIRM EXACT OPENING SIZES WITH WINDOW ORDER / SHOP DRAWINGS PRIOR TO FRAMING NO FINGER JOINED MATERIAL TO BE USED ON ANY PART OF WINDOW OR DOORS INCLUDING BUT NOT LIMITED TO, SECONDARY SURFACES, SUB SILL, EXTERIOR CASINGS, BLIND STOPS, ETC.




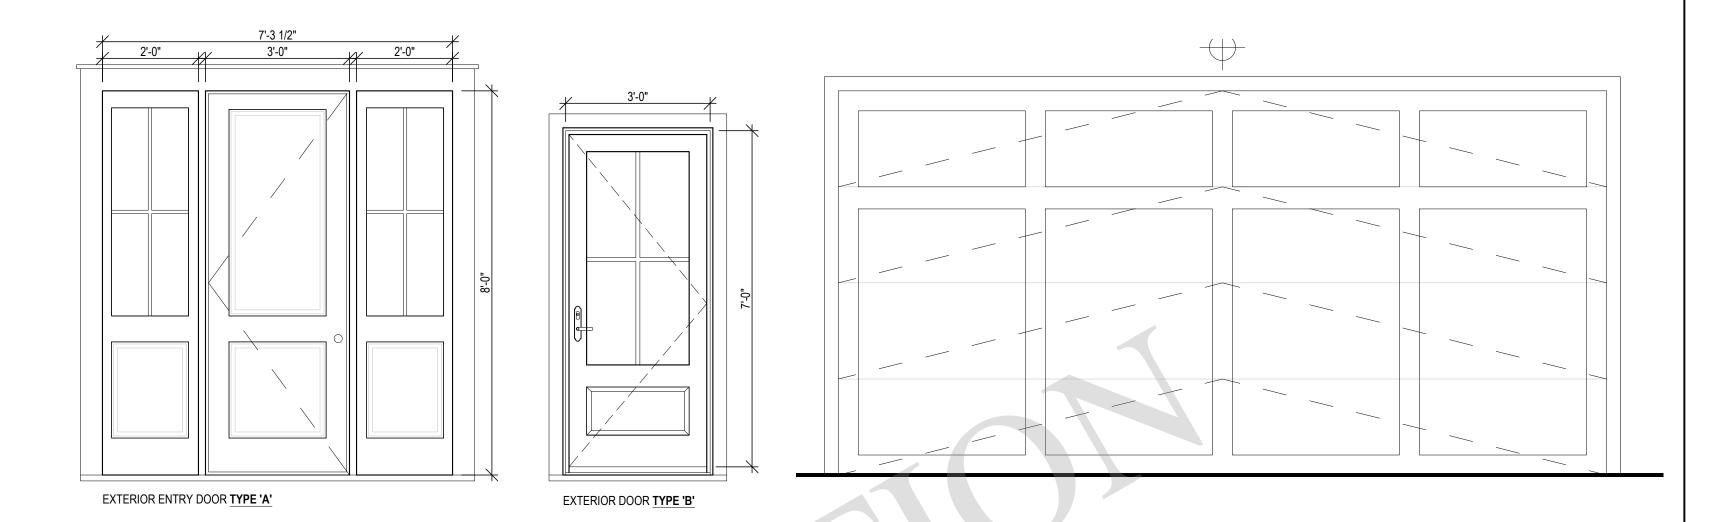


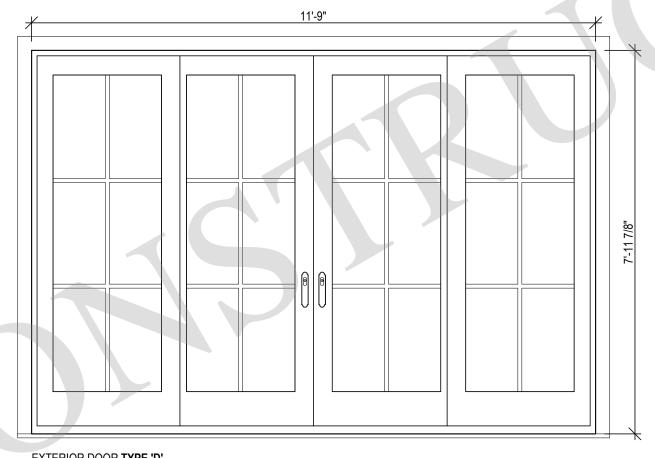





2 EXTERIOR DOOR TYPES

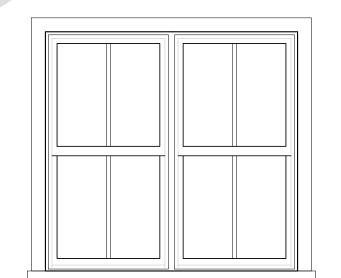

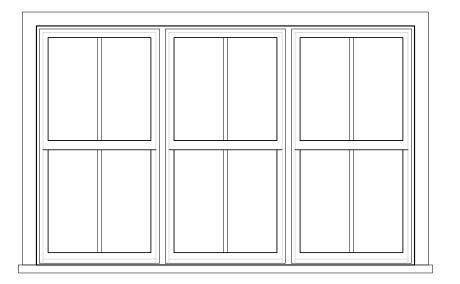

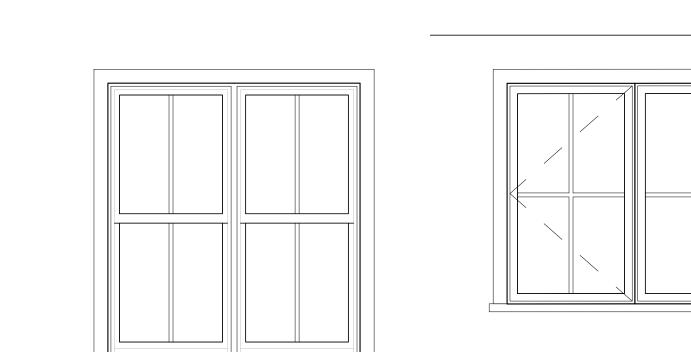

NOTE:
CONTRACTOR TO SUBMIT SHOP DRAWINGS TO ARCHITECT FOR REVIEW OF ALL DOORS & WINDOWS PRIOR TO ORDERING.

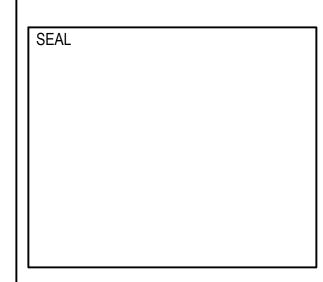

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PROPOSED
WINDOW TYPES &

SCALE: AS NOTED

SCHEDULE

