ARCHITECT

JOSEPH PAGAC ARCHITECT P.C. JPA

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Westhampton Beach, New York 11978
P: 631.557.0070

PROJECT NO.: 2106

DATE: 6/16/2021


DRAWN BY: CD CHECKED BY: JP

DRAWING TITLE

PROPOSED SITE PLAN

SCALE: AS NOTED

A-010

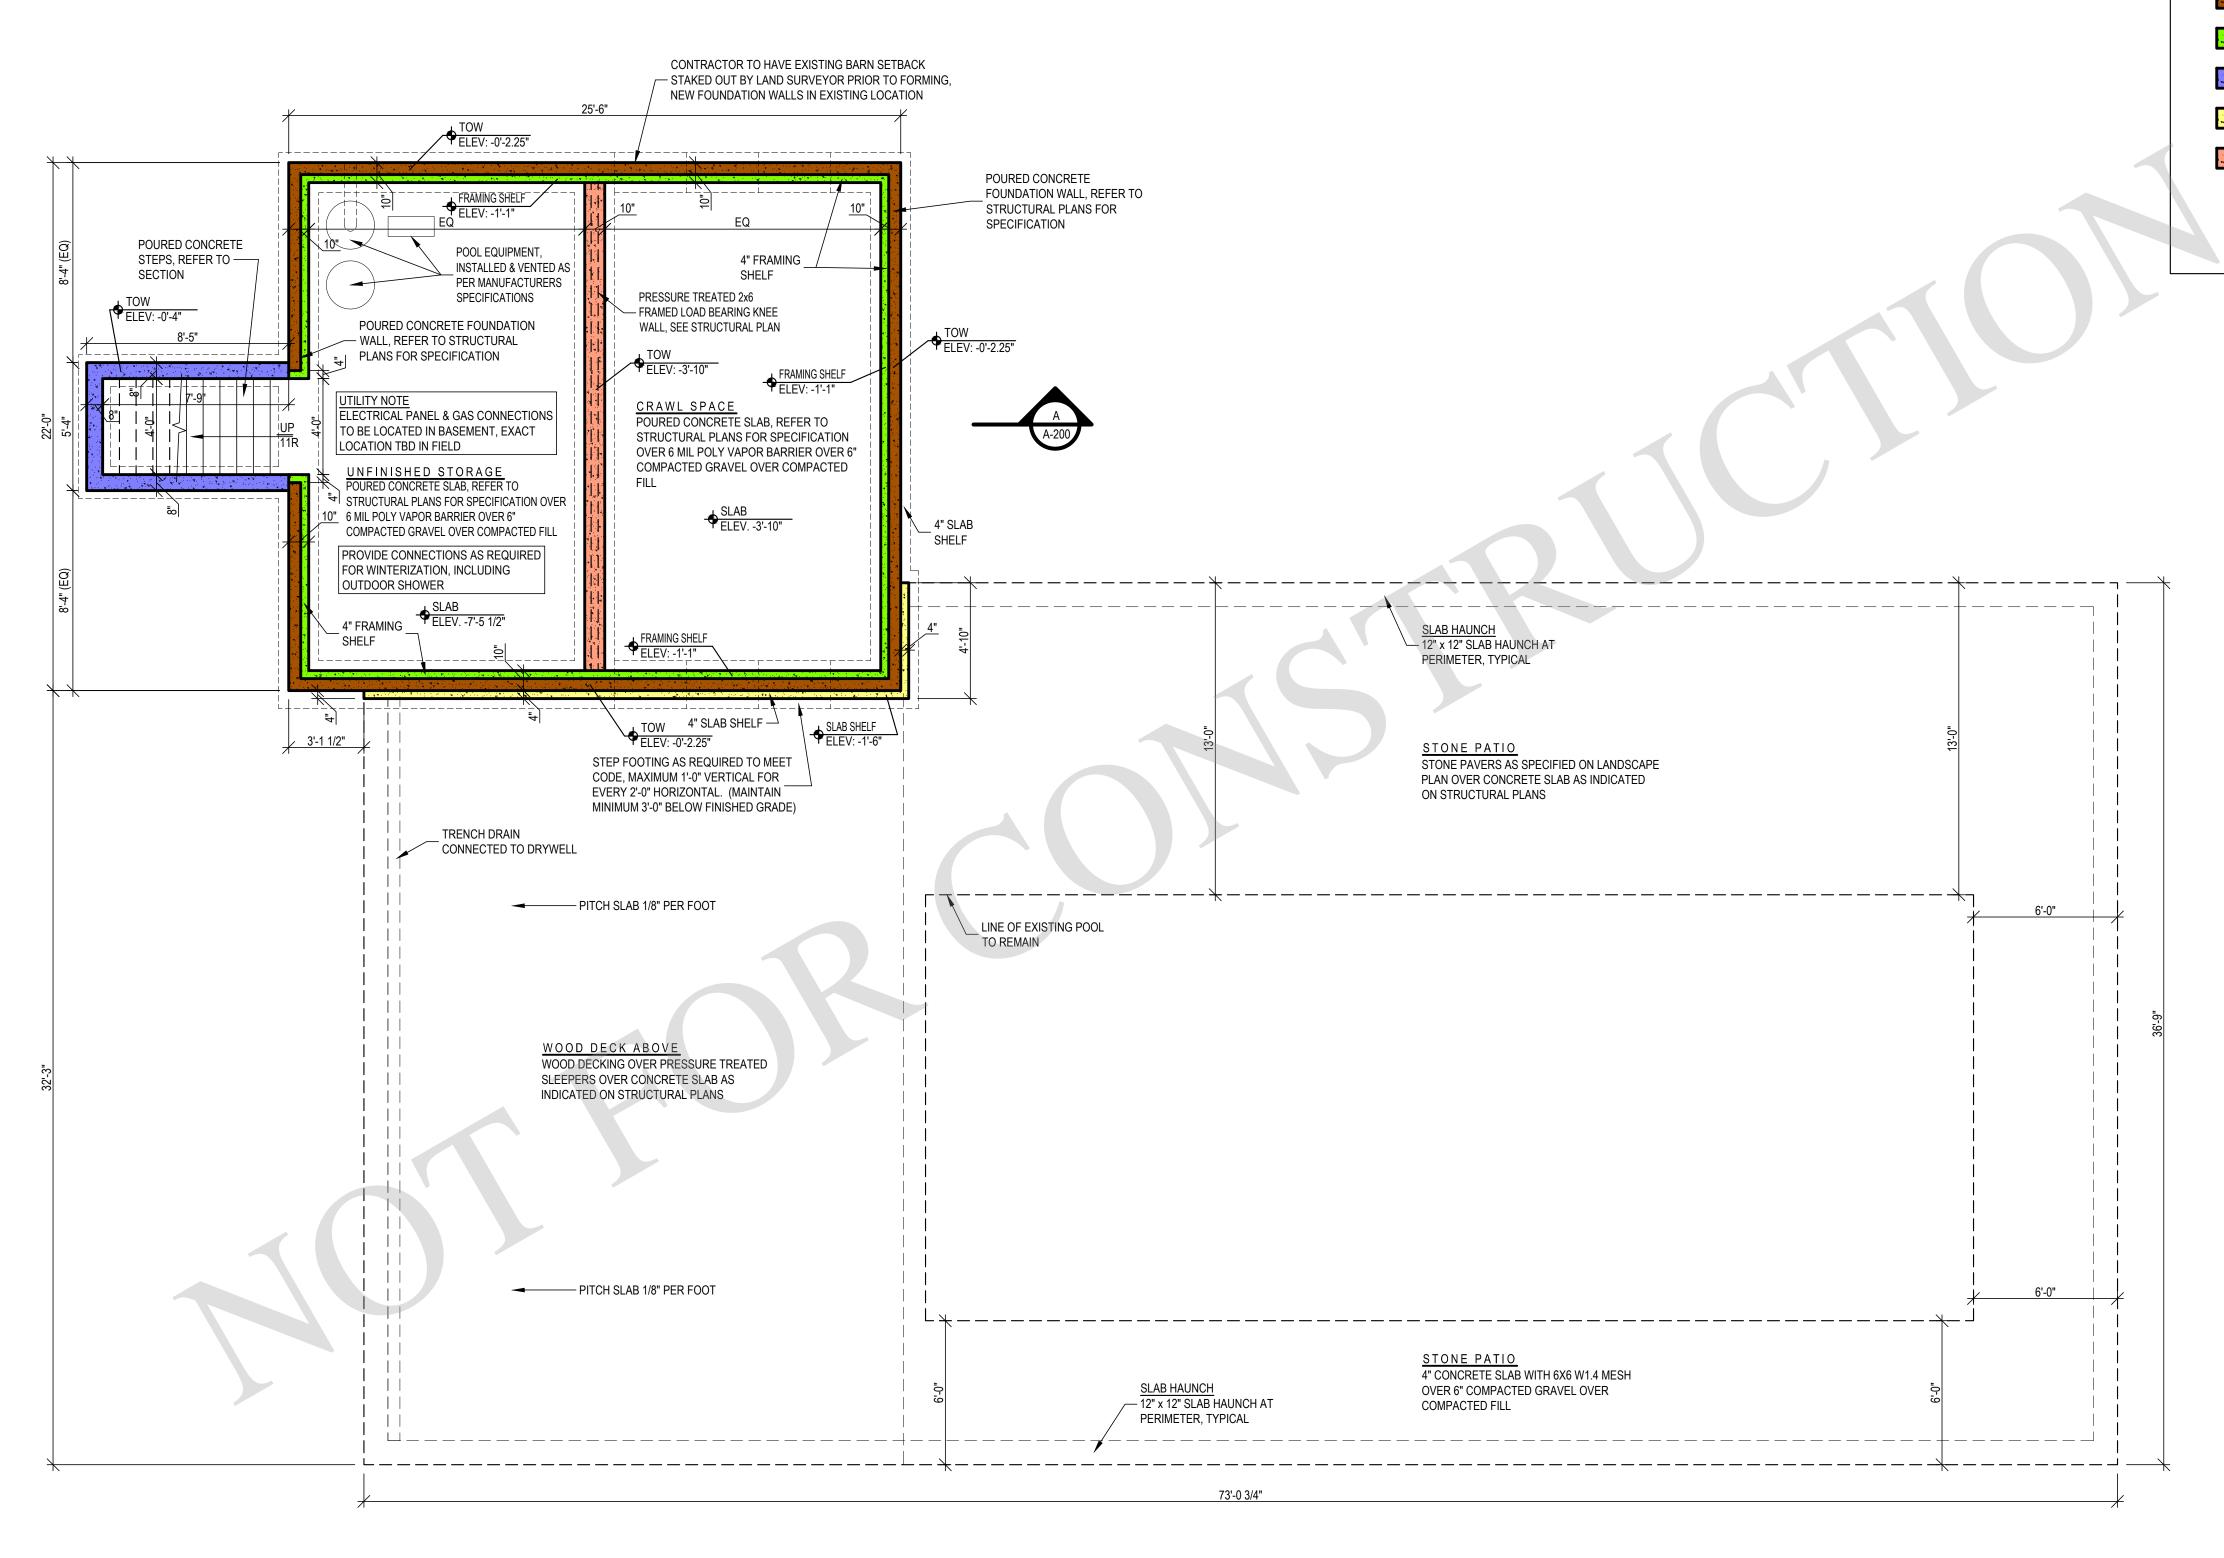

COLOR CODED DRAWING, PLEASE CONFIRM DRAWING IS A COLOR COPY PRIOR TO CONSTRUCTION

WALL HEIGHT LEGEND

TOP OF 1ST FLOOR SUBFLOOR: ELEV 0'-0"

T.O.W. : ELEV -0'-2 1/4"

T.O.W. : ELEV -1'-1"

T.O.W.: ELEV -0'-4" (VERIFY IN FIELD WITH GRADE CONDITIONS)

T.O.W. : ELEV -1'-6"

T.O.W. : ELEV -3'-10"

TOP OF BASEMENT SLAB: ELEV. -7'-5 1/2"
TOP OF FOOTING: ELEV. -7'-9 1/2"
BOTTOM OF FOOTING: ELEV. -8'-9 1/2"

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PROPOSED FOUNDATION PLAN


SCALE: AS NOTED

A-100

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PROPOSED FOUNDATION PLAN

1/4" = 1'-0"

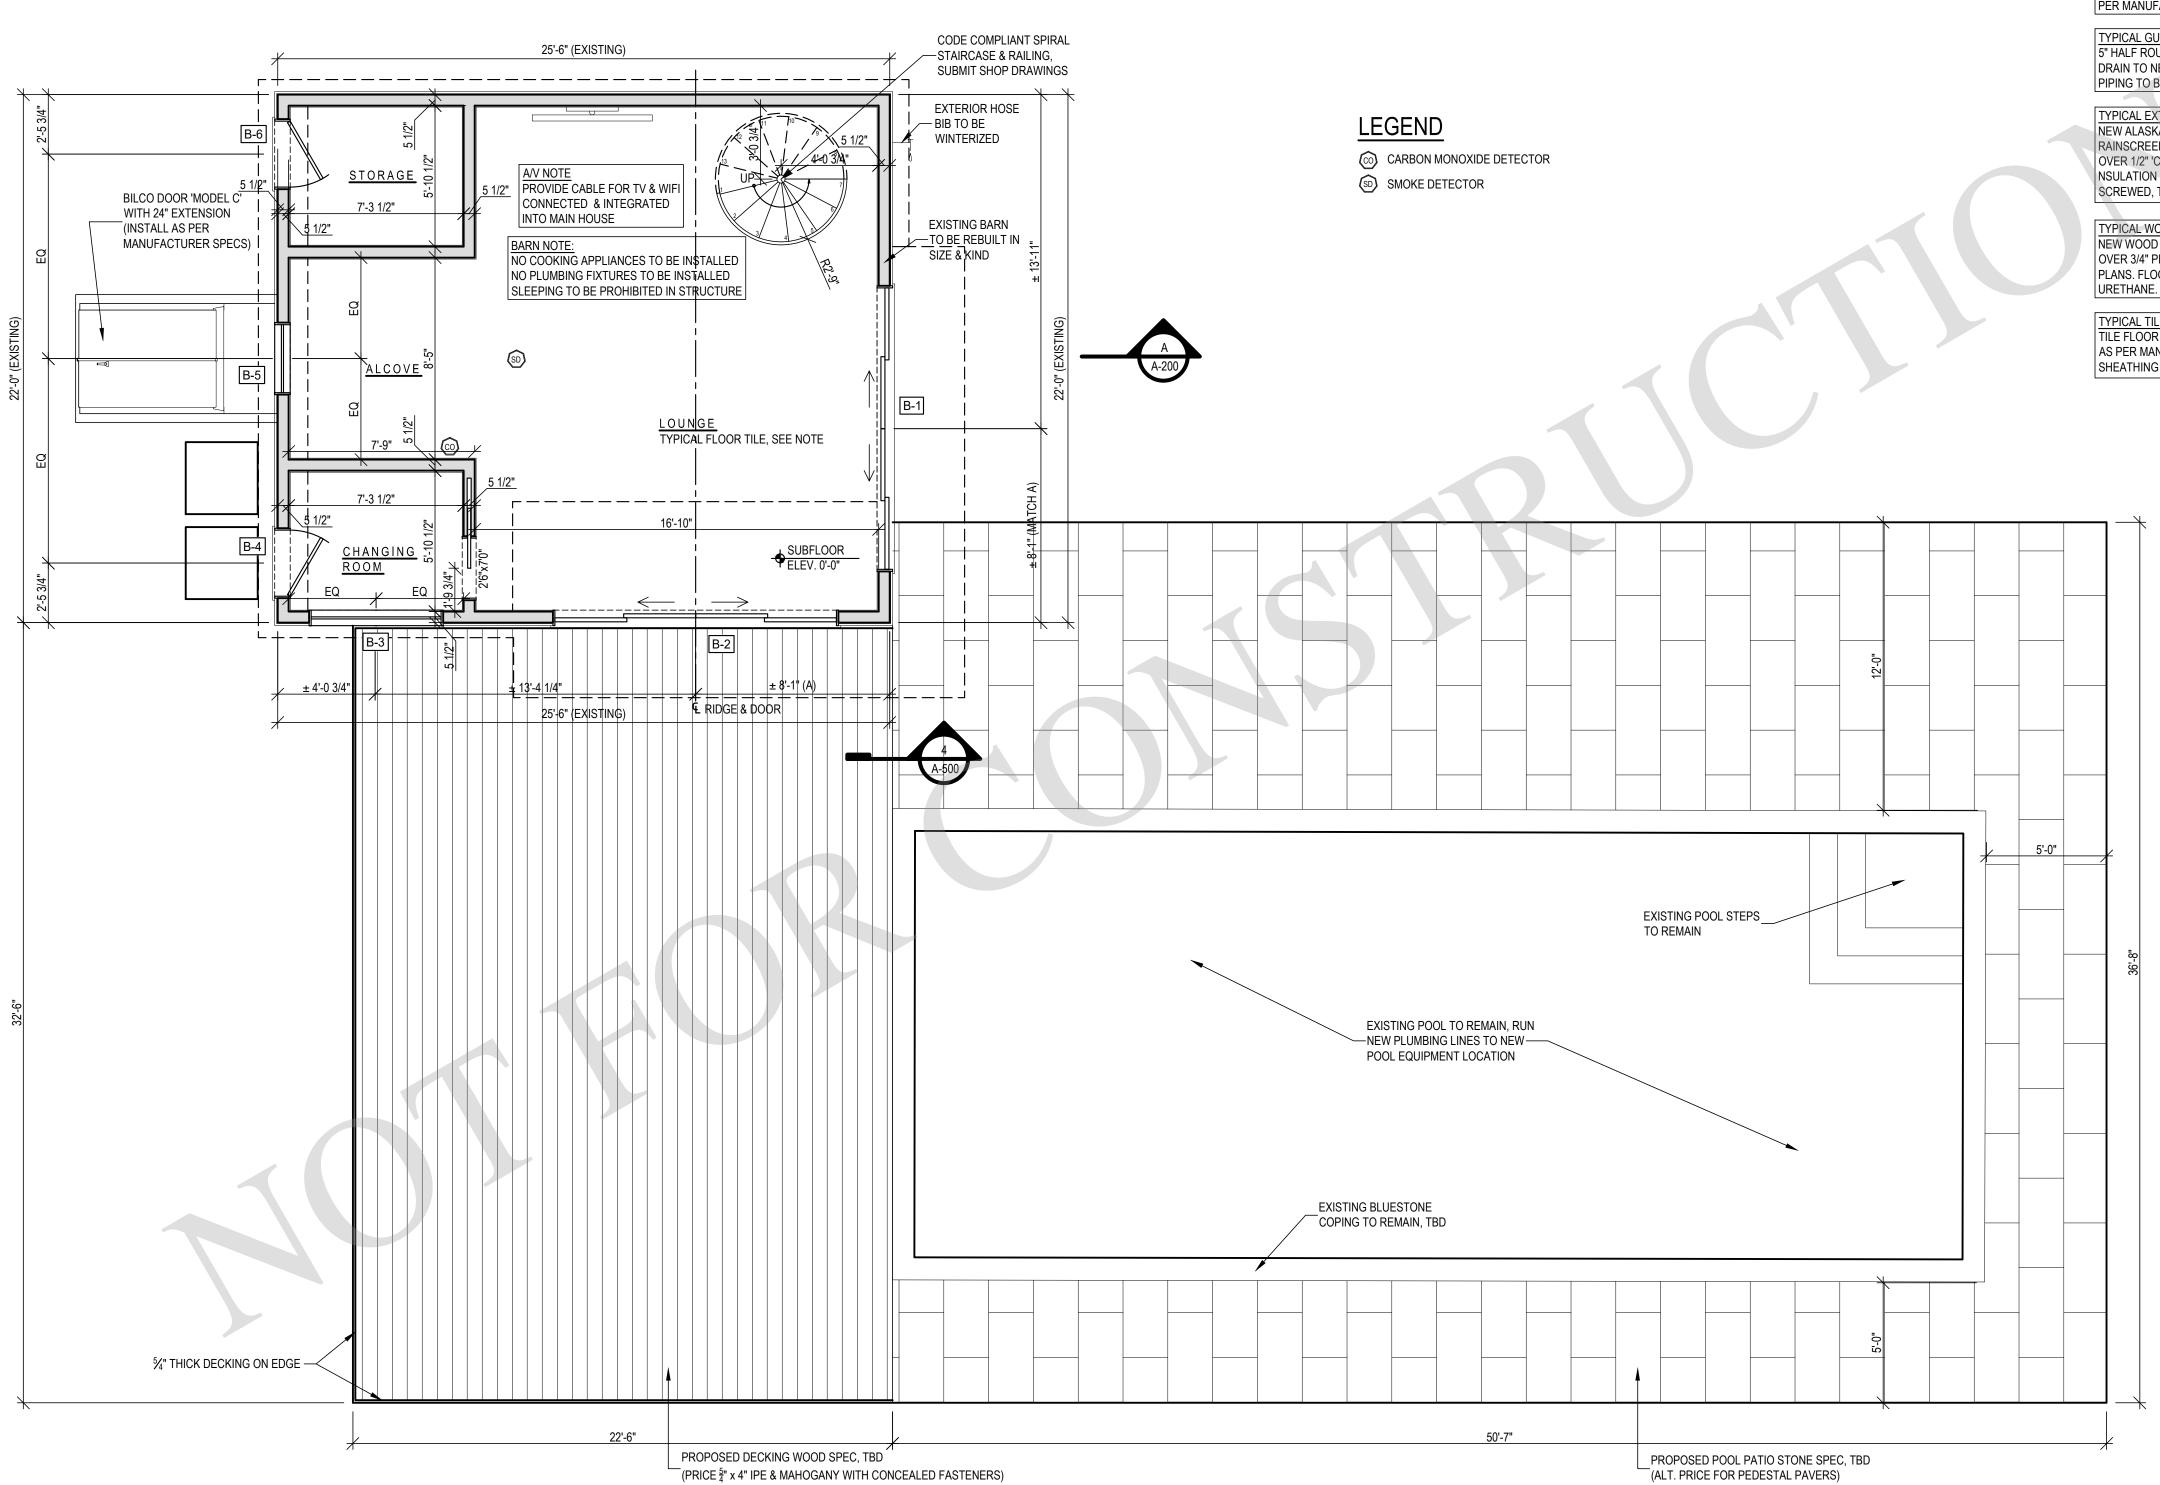

1 PROPOSED FIRST FLOOR PLAN

1/4" = 1'-0"

TYPICAL ROOF
ALASKAN YELLOW CEDAR ROOF SHINGLES TO BE TAPER SAWN 5/8" THICK x 18" LONG, RANDOM | WIDTH, OVER 'CEDAR BREATHER' (BENJAMIN OBDYKE) OVER 30# BUILDING FELT OVER 5/8" 'CDX' |

PLYWOOD SHEATHING OVER ROOF RAFTERS (SEE PLAN). INSTALL 'HENRY RF200' ICE & WATER SHIELD FROM THE EAVES EDGE TO A POINT AT LEAST 2'-0" INSIDE THE EXTERIOR WALL LINE AS INDICATED ON ROOF PLAN AND AS REQUIRED TO MEET CODE.

TYPICAL FLAT ROOF

INSTALL .090 FIRESTONE EPDM SELF-ADHERED ROOFING MEMBRANE OVER 1/2" FIRESTONE ISOGUARD COVER BOARD OVER TAPERED INSULATION PANELS (1/4" / FT MIN), OR APPROVED EQUAL, OVER 5/8"" CDX PLYWOOD SHEATHING OVER ROOF RAFTERS, SEE STRUCTURAL DRAWINGS. ROOFING TO BE INSTALLED AS PER MANUFACTURERS SPECIFICATIONS

ZINC COATED COPPER WELDED SEAM FLAT ROOF OVER 30 #LB FELT, OVER 5/8"" CDX PLYWOOD SHEATHING OVER ROOF RAFTERS, SEE STRUCTURAL DRAWINGS. ROOFING TO BE INSTALLED AS PER MANUFACTURERS SPECIFICATIONS

TYPICAL GUTTER
5" HALF ROUND ZINC COATED COPPER GUTTERS (COLOR TO BE BLACK) WITH 3"Ø LEADERS TO DRAIN TO NEW DRYWELL SYSTEM (SEE SITE PLAN FOR SIZE & LOCATION). ALL UNDERGROUND PIPING TO BE SCHEDULE 40 PVC SDR 35.

TYPICAL EXTERIOR WALL - CEDAR SIDING

NEW ALASKAN YELLOW CEDAR SHINGLES (5" EXPOSURE) OVER 'BENJAMIN OBDYKE SLICKER MAX' RAINSCREEN OVER 'BENJAMIN OBDYKE HYDROGAP SA' SELF-ADHERED DRAINABLE HOUSEWRAP OVER 1/2" 'CDX' PLYWOOD SHEATHING OVER WOOD STUD WALL. FILLED WITH SPRAY FOAM NSULATION & INTERIOR WALL FINISH AS PER INTERIOR ELEVATIONS (5/8" GYPSUM BOARD TO BE SCREWED, TAPED, SPACKLED (3 COATS), & SANDED, READY FOR PAINT.)

NEW WOOD FLOOR TO BE 8" WIDE ENGINEERED WHITE OAK INSTALLED OVER RED ROSEN PAPER OVER 3/4" PLYWOOD SHEATHING (GLUED & SCREWED) OVER FLOOR JOIST AS SPECIFIED ON PLANS. FLOOR TO BE SCRAPED, SANDED, STAINED, SEALED, AND RECEIVE 3 COATS POLY

TYPICAL TILE FLOOR
TILE FLOOR OVER 'DITRA' UNCOUPLING MAT MANUFACTURED BY 'SCHLUTER SYSTEMS' (INSTALL AS PER MANUFACTURERS SPECIFICATIONS) OVER #30 BUILDING PAPER OVER 3/4" PLYWOOD SHEATHING (GLUED & SCREWED) OVER FLOOR JOIST AS SPECIFIED ON PLANS

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DATE: 6/16/2021

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PROPOSED FIRST FLOOR PLAN


SCALE: AS NOTED

CHECKED BY: JP



© CARBON MONOXIDE DETECTOR

SD SMOKE DETECTOR

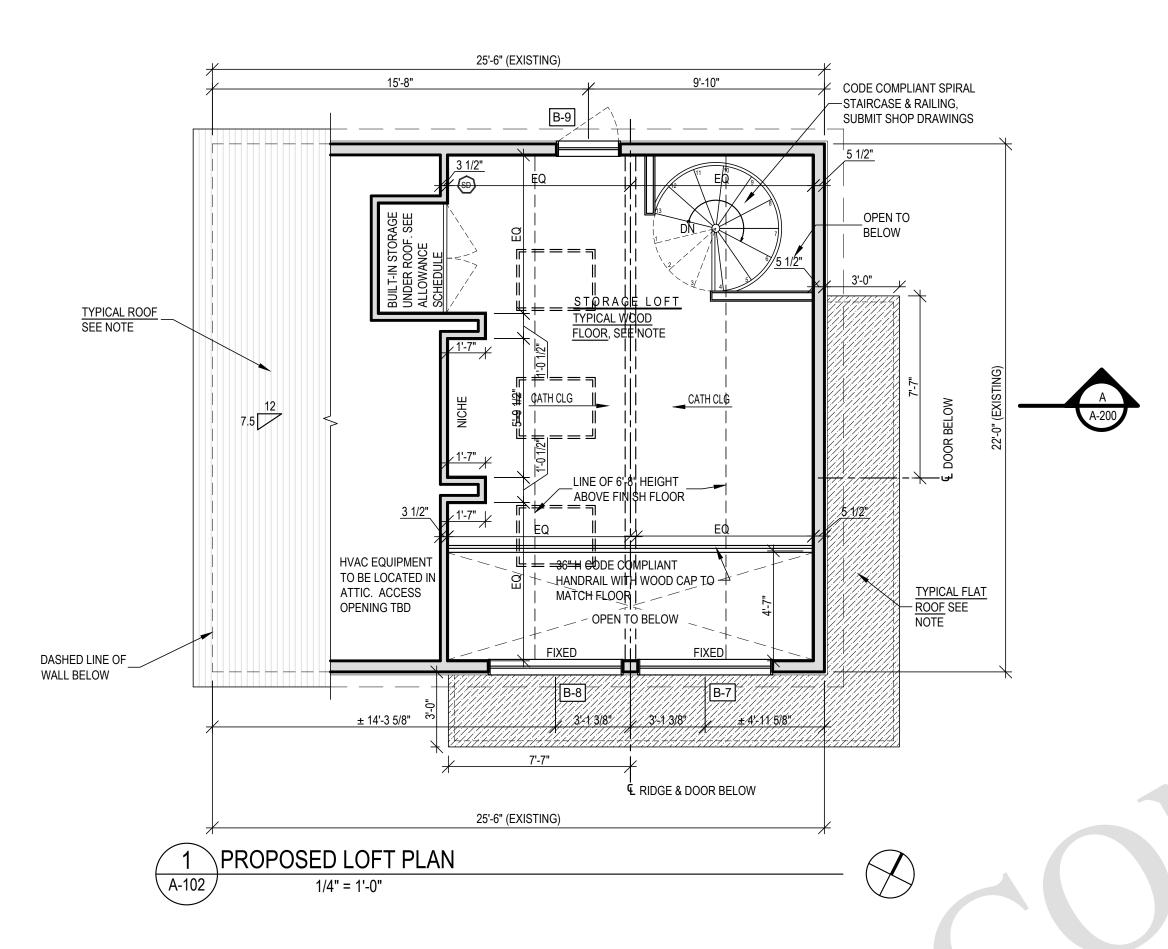

TYPICAL ROOF
ALASKAN YELLOW CEDAR ROOF SHINGLES TO BE TAPER SAWN 5/8" THICK x 18" LONG, RANDOM WIDTH, OVER 'CEDAR BREATHER' (BENJAMIN OBDYKE) OVER 30# BUILDING FELT OVER 5/8" 'CDX' PLYWOOD SHEATHING OVER ROOF RAFTERS (SEE PLAN). INSTALL 'HENRY RF200' ICE & WATER SHIELD FROM THE EAVES EDGE TO A POINT AT LEAST 2'-0" INSIDE THE EXTERIOR WALL LINE AS

INDICATED ON ROOF PLAN AND AS REQUIRED TO MEET CODE.

TYPICAL FLAT ROOF
INSTALL .090 FIRESTONE EPDM SELF-ADHERED ROOFING MEMBRANE OVER 1/2" FIRESTONE ISOGUARD COVER BOARD OVER TAPERED INSULATION PANELS (1/4" / FT MIN), OR APPROVED EQUAL, OVER 5/8"" CDX PLYWOOD SHEATHING OVER ROOF RAFTERS, SEE STRUCTURAL DRAWINGS. ROOFING TO BE INSTALLED AS PER MANUFACTURERS SPECIFICATIONS


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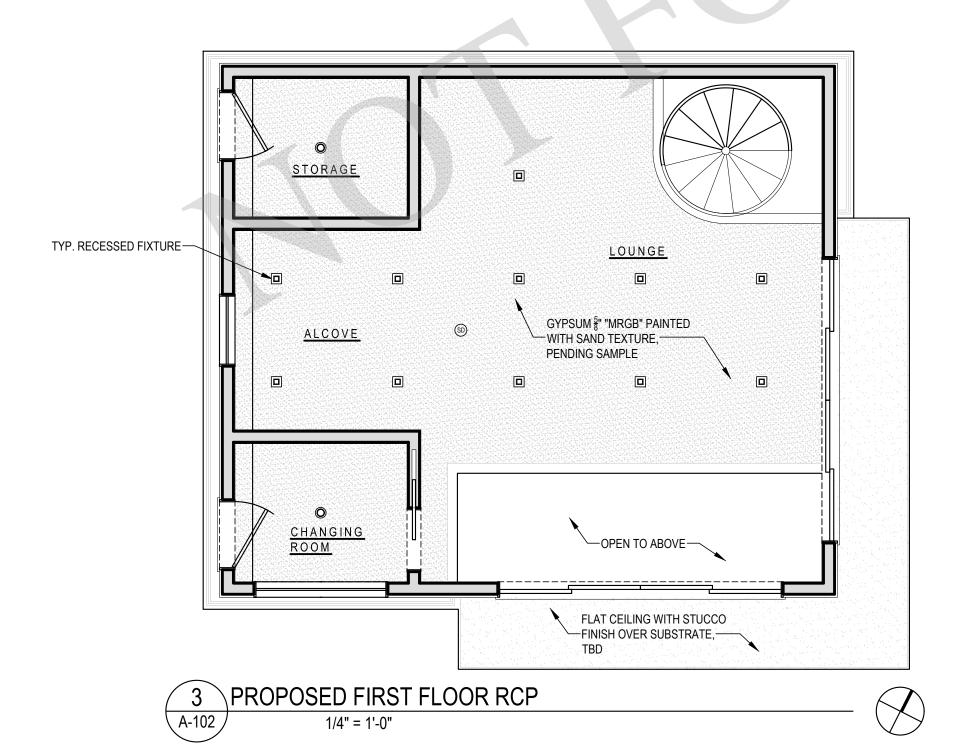
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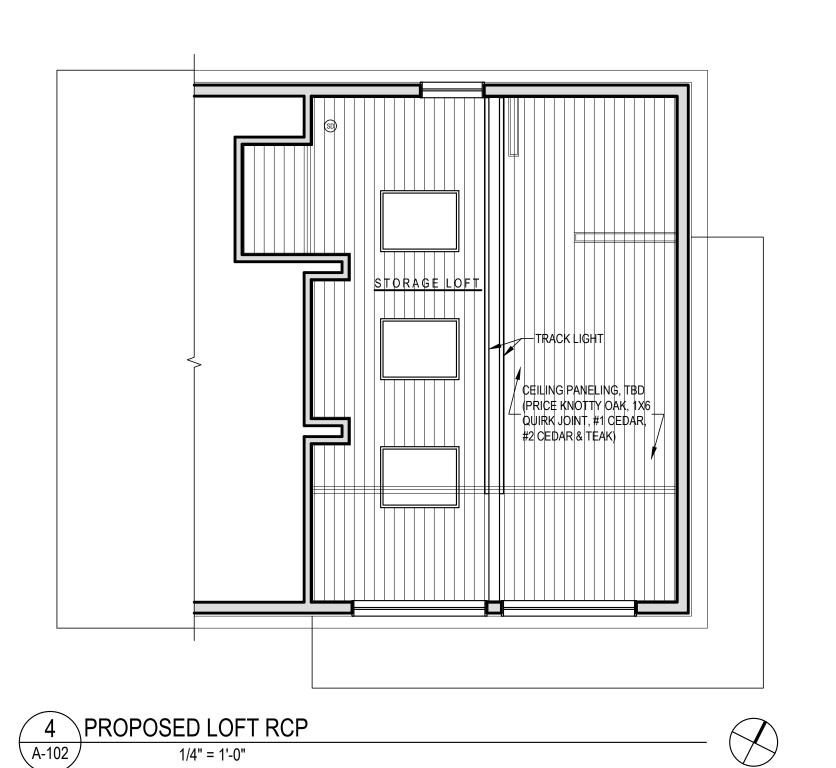
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\PROPOSED ROOF PLANS






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PROJECT NO.: 2106 DATE: 6/16/2021 DRAWN BY: CD CHECKED BY: JP DRAWING TITLE

PROPOSED LOFT PLAN & ROOF PLAN & RCP

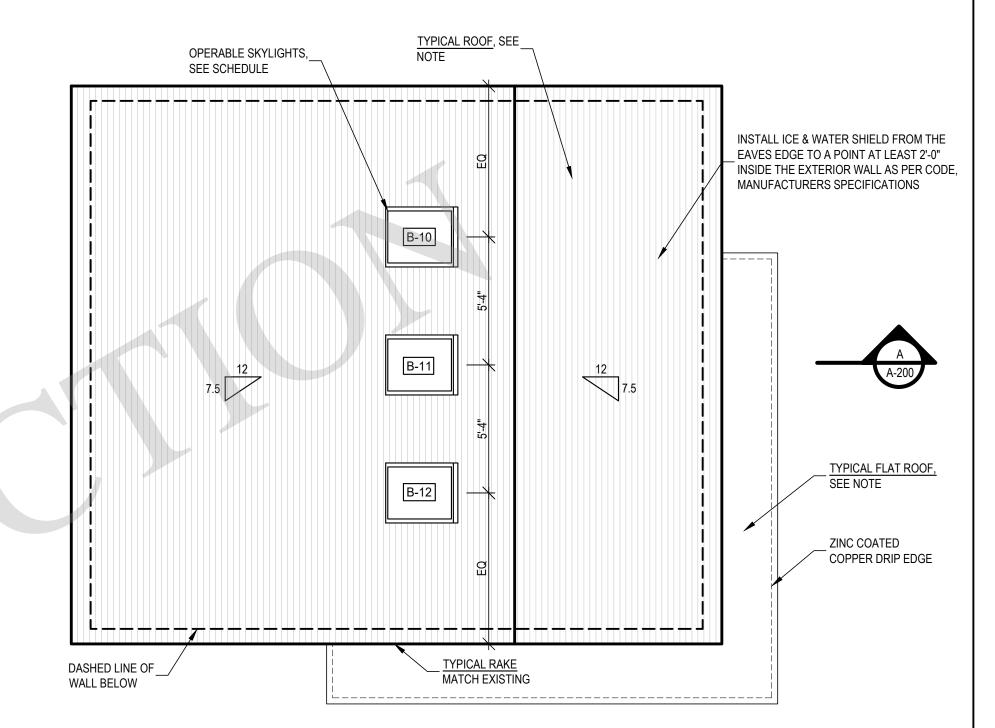SCALE: AS NOTED

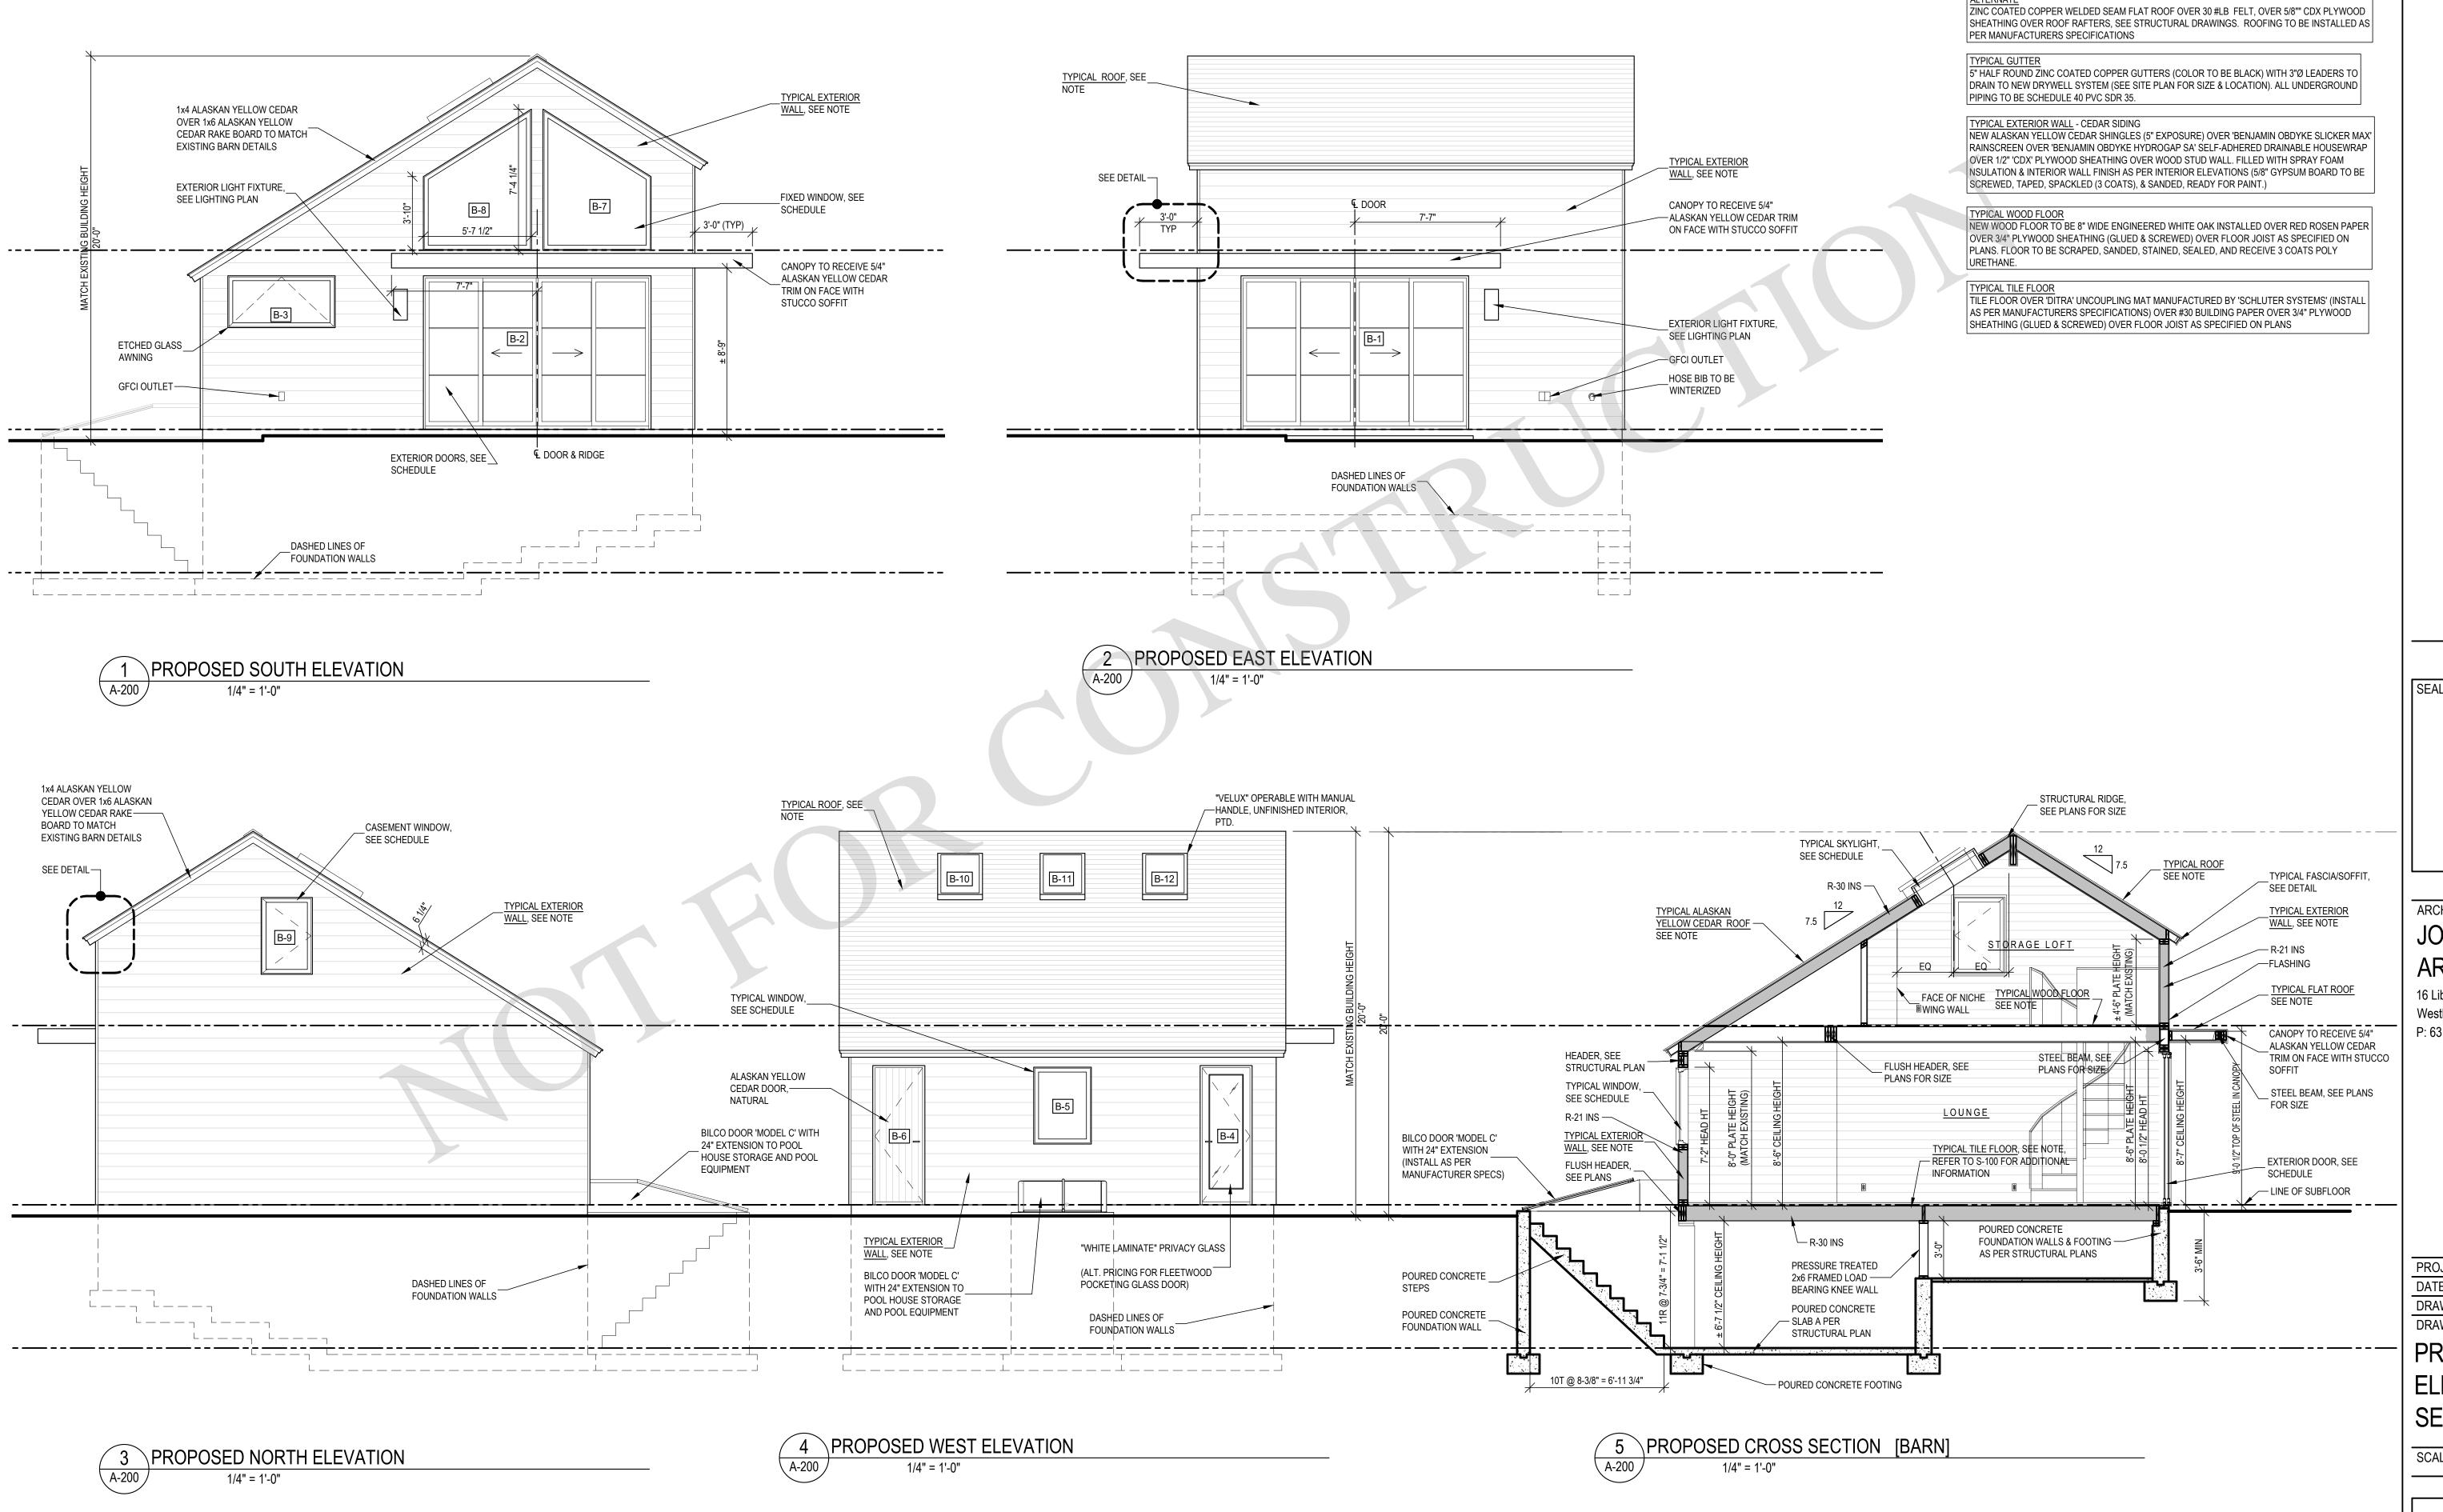

ALASKAN YELLOW CEDAR ROOF SHINGLES TO BE TAPER SAWN 5/8" THICK x 18" LONG, RANDOM | WIDTH, OVER 'CEDAR BREATHER' (BENJAMIN OBDYKE) OVER 30# BUILDING FELT OVER 5/8" 'CDX' | PLYWOOD SHEATHING OVER ROOF RAFTERS (SEE PLAN). INSTALL 'HENRY RF200' ICE & WATER SHIELD FROM THE EAVES EDGE TO A POINT AT LEAST 2'-0" INSIDE THE EXTERIOR WALL LINE AS INDICATED ON ROOF PLAN AND AS REQUIRED TO MEET CODE.

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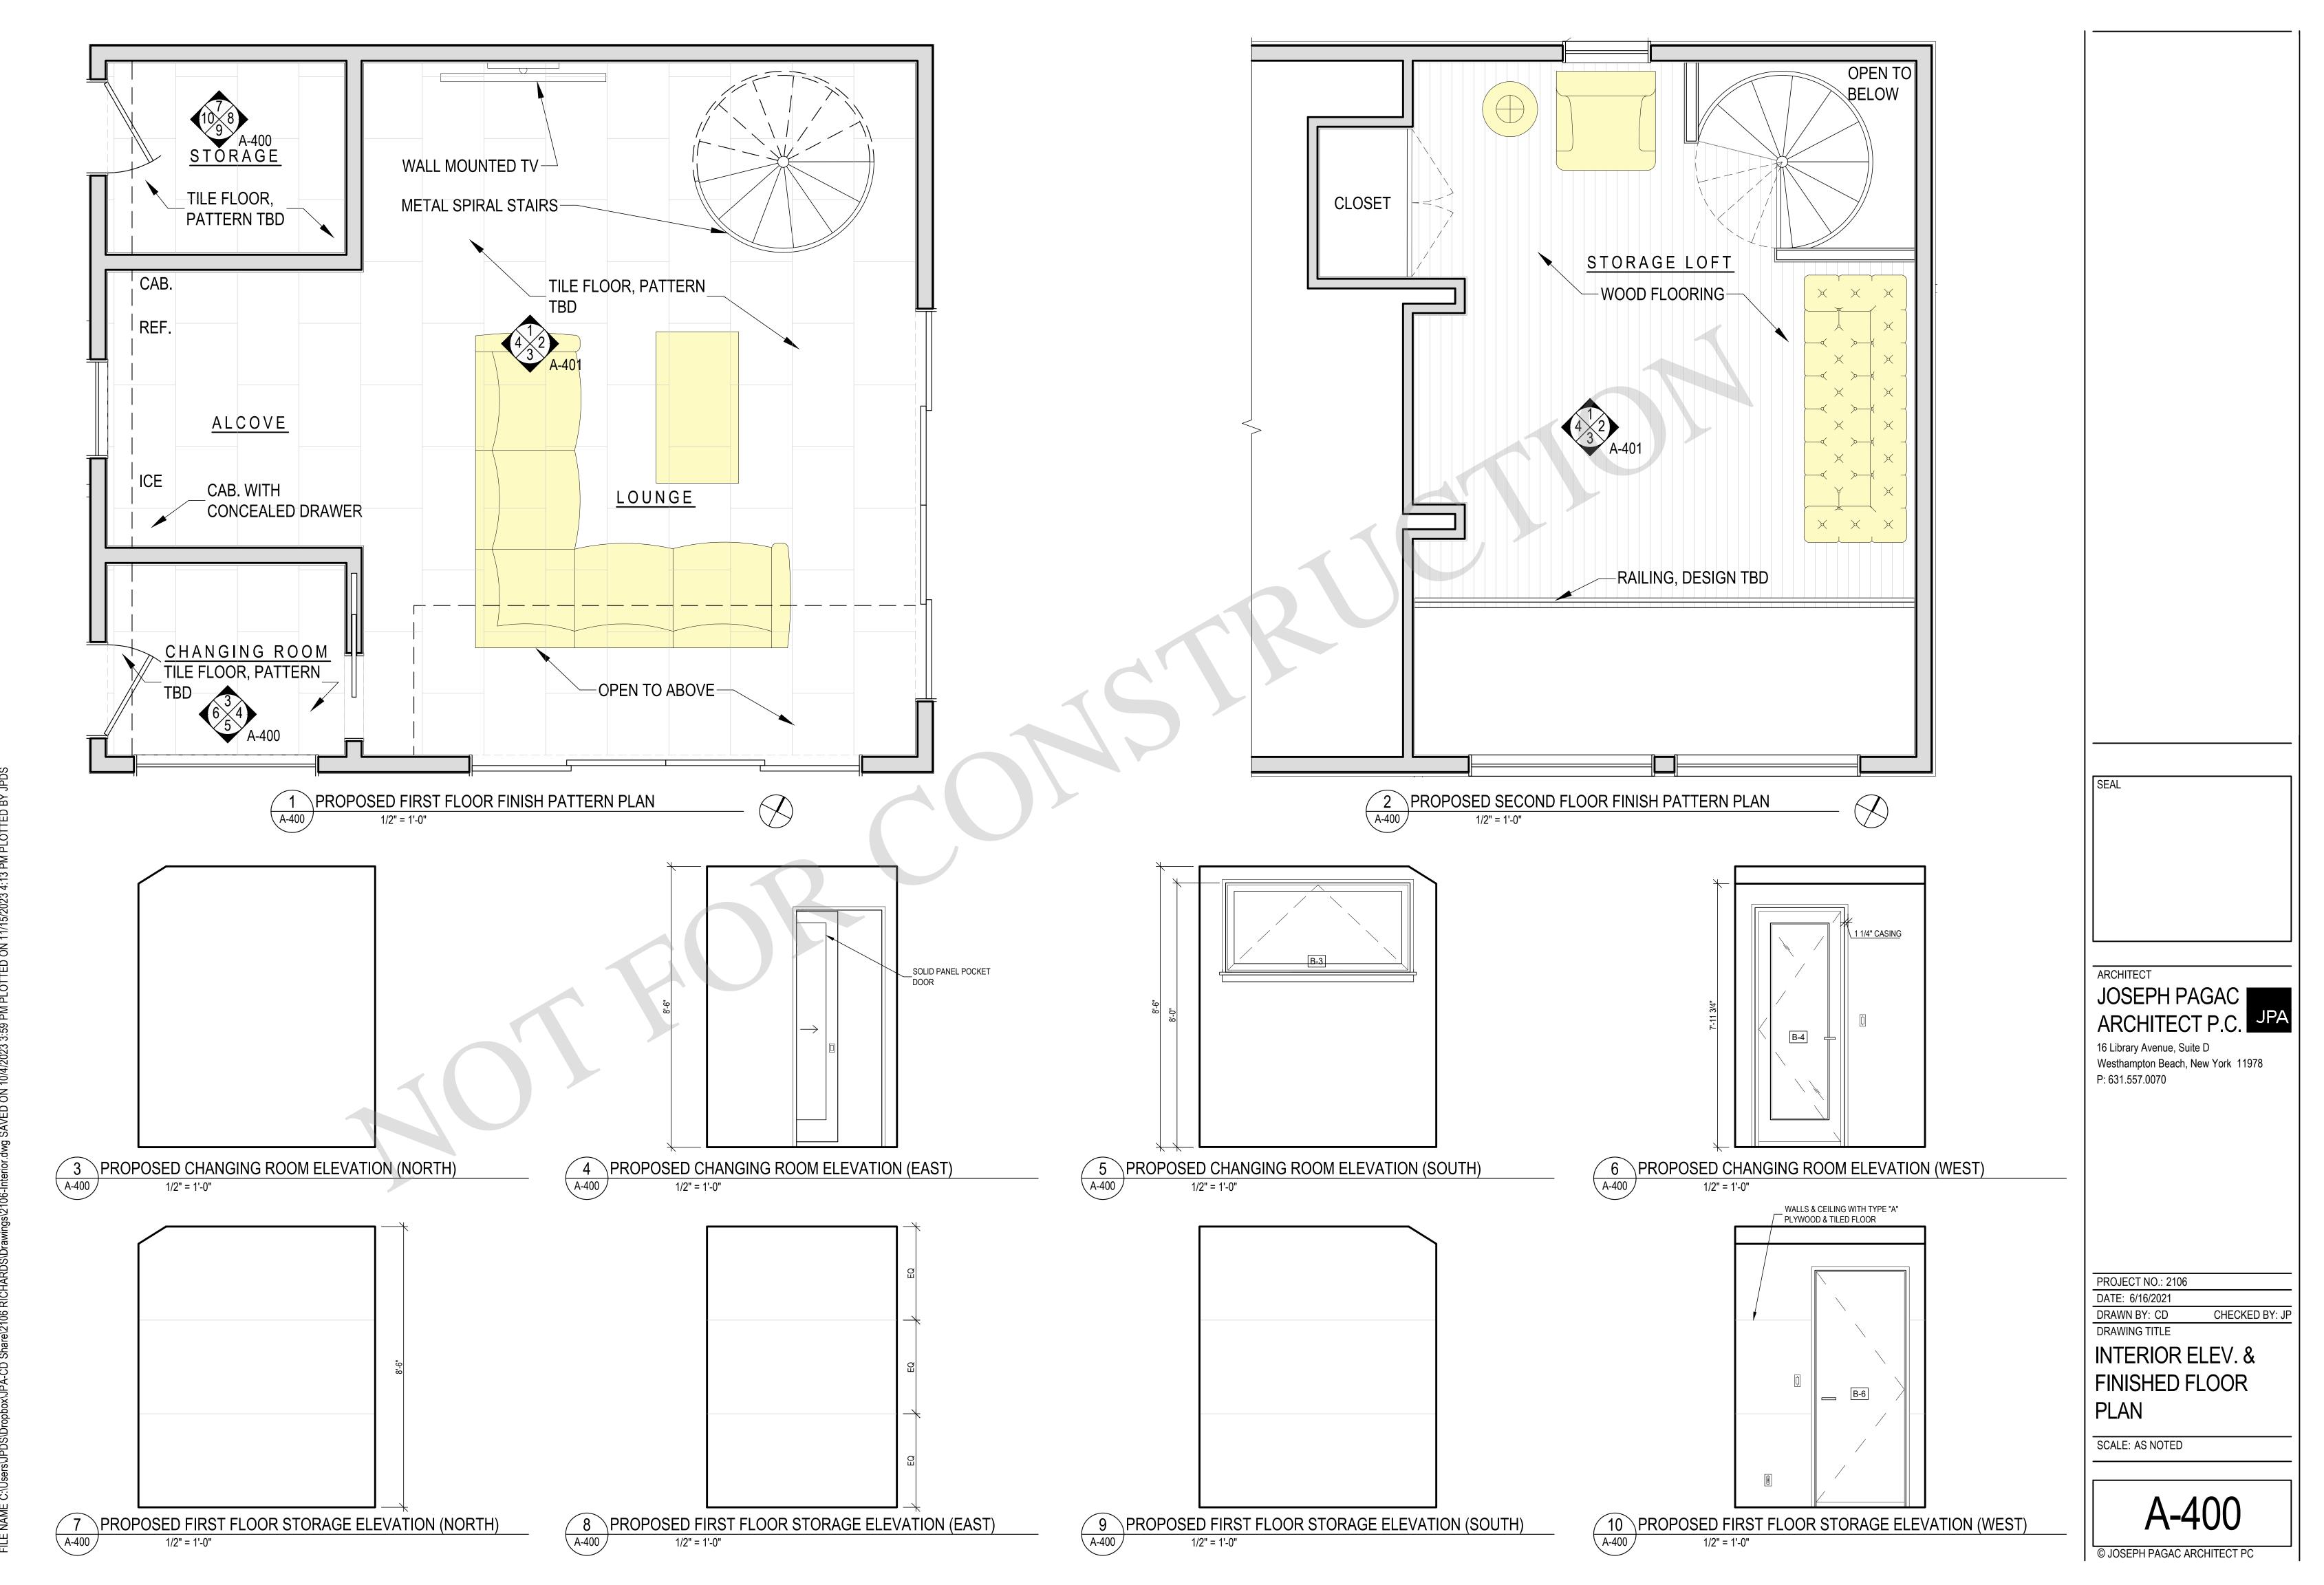
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DRAWING TITLE PROPOSED EXTERIOR

ELEVATIONS & CROSS SECTION

SCALE: AS NOTED



1 1/4" CASING, WESTERN RED

2.5" x2.5" CORNER POST

CEDAR TRIM TO MATCH WALLS

OUTLET

SCONCE, FBO, LOCATION TBD

5/4x2.5 BALUSTERS (±3" OC SPACING)

NOTE:
FINAL HEIGHT OF ALL OUTLETS & SWITCHES TBD IN
FIELD. OUTLETS & SWITCHES TO FALL WITHIN FULL

BOARD OF WALL PANELING


GYPSUM CEILING,

"SAND PAINT" FINISH


1X6 CLEAR WESTERN RED CEDAR WITH 🖁 QUIRK JOINT —


36" H CLEAR CEDAR RAILING


5/4x2.5 TOP RAIL 5/4x2.5 BOTTOM RAIL

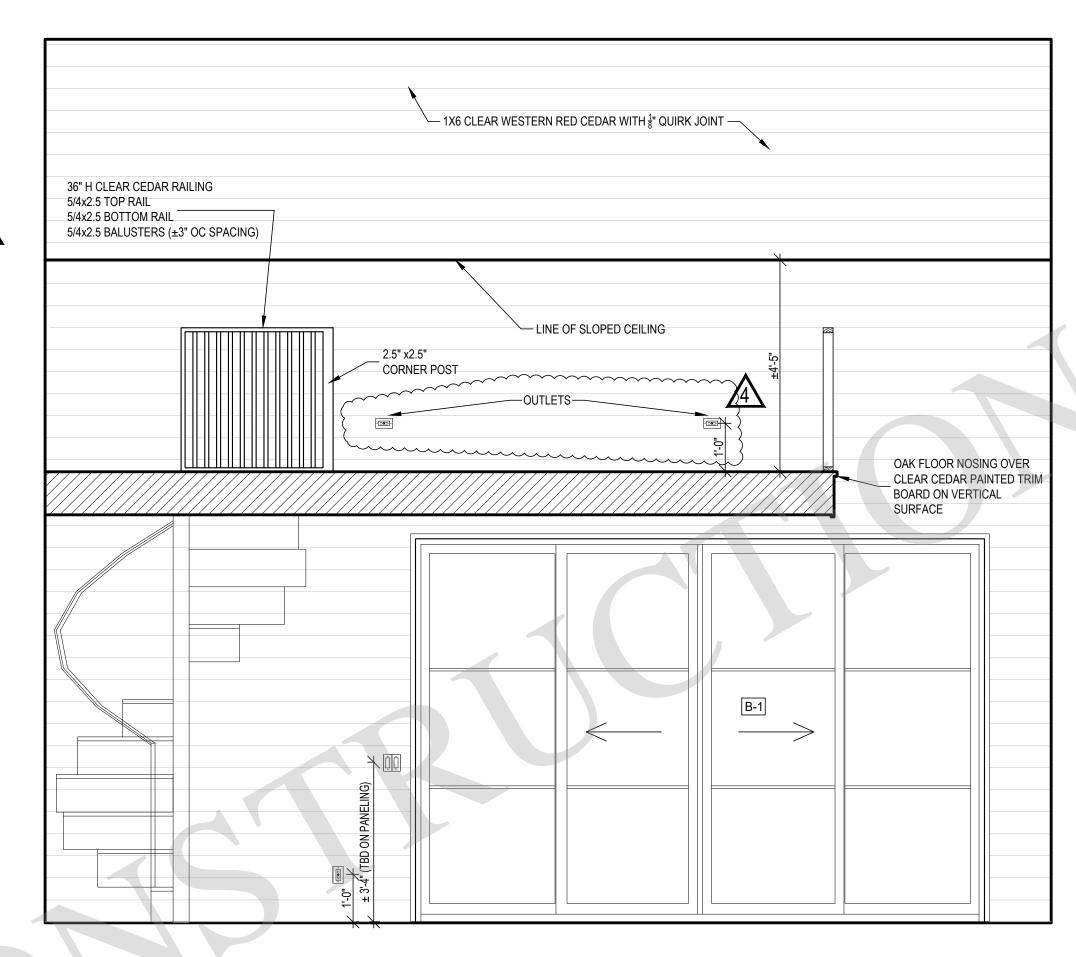

2 PROPOSED FIRST FLOOR LOUNGE ELEVATION (EAST) A-401

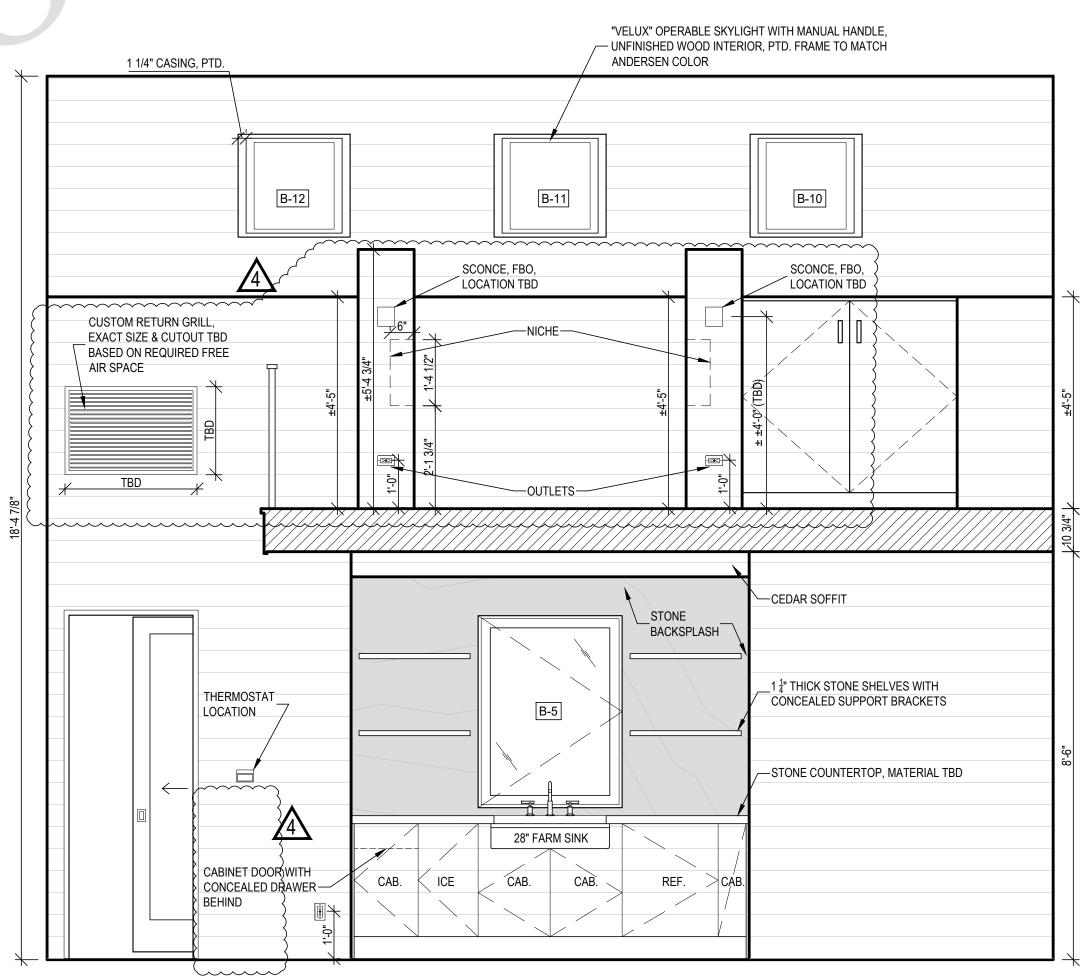

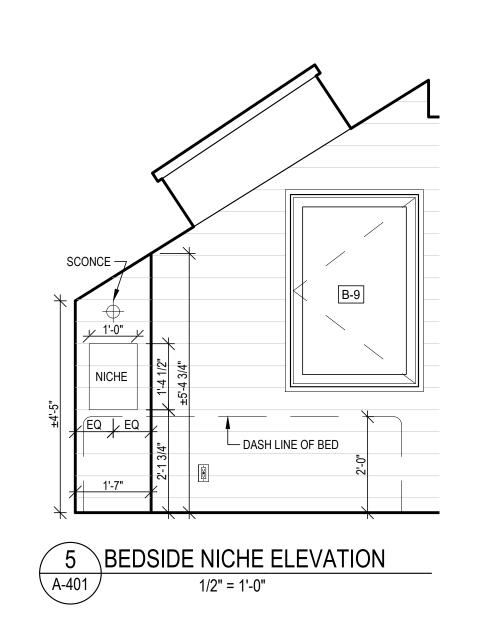

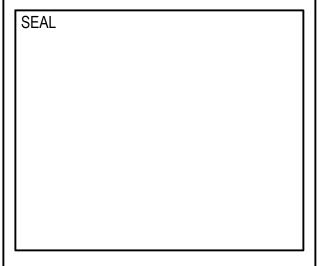

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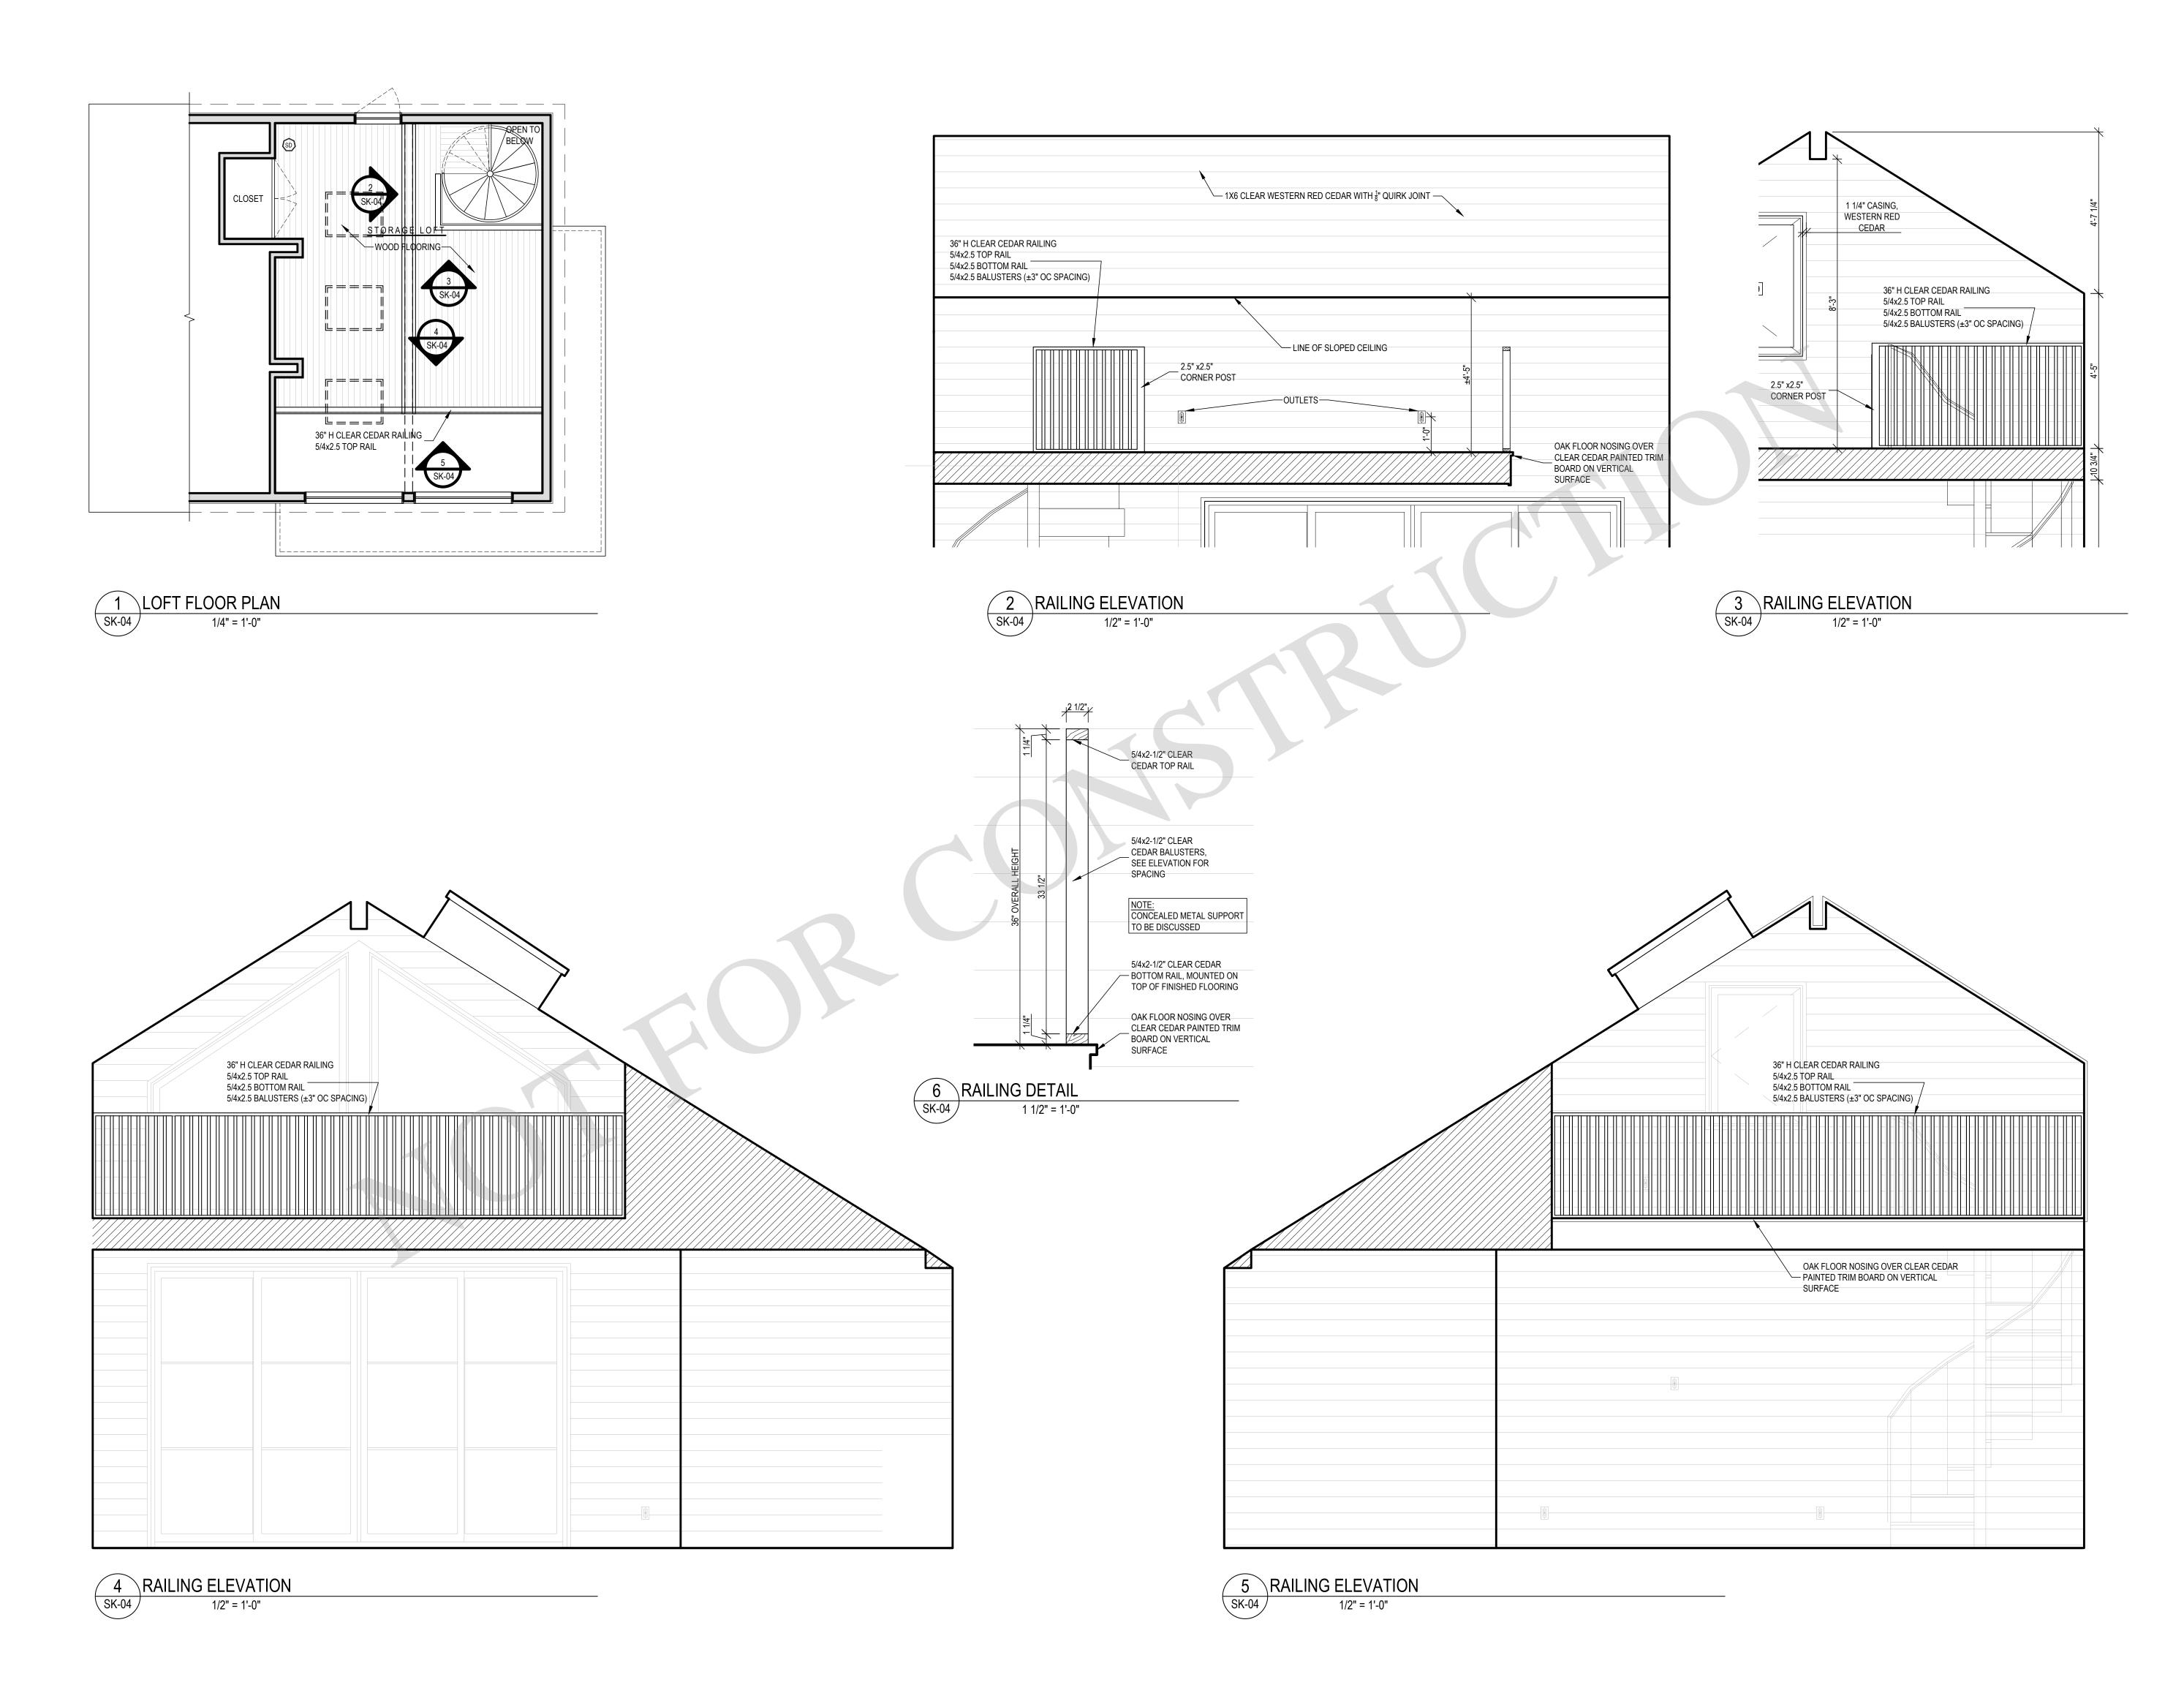
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CONCEPTUAL INTERIOR ELEV. & | FINISHED FLOOR PLAN|

SCALE: AS NOTED

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4 PROPOSED FIRST FLOOR LOUNGE ELEVATION (WEST) A-401 1/2" = 1'-0"



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DRAWING TITLE

INTERIOR RAILINGS

SCALE: AS NOTED

ALLOWANCE SCHEDULE											11/15/2023
ALLOWANCE SCHEDULE IS TO BE USE CONTRACTOR TO INCLUDE PRICE FO	ED FOR BIDDING PURPOSES ONLY. SCHEDULE DOES NO	T REPRESENT ACT	UAL	FINAL SELEC	CTION	COST. PRICE	INDICAT	ED IS FOR PURC	HASE OF MATERIAL ONL	Υ.	
LOCATION	ITEM	QUANTITY		MATERIA	L ALL	OWANCE		TOTAL	MANUFACTURER	MODEL#	NOTES
BARN LOUNGE											
	SPIRAL STAIRCASE	1.00			\$	8,000.00	/ PC	\$ 8,000.00			
	FLOOR TILE	451.00	SF	TILE	\$	12.00	/ SQ FT	\$ 5,412.00			
BARN LOFT											
	BUILT IN STORAGE	4.75	LF		\$	750.00	/ LF	\$ 3,562.50			
ELECTRICAL											
	LIGHTING CONTROLS	1.00			\$	10,000.00	/ PC	\$10,000.00			
TOTAL	\$ 26,974.5	60	CONTRACTOR TO INCLUDE PRICE OF INSTALLATION IN PROPOSAL								


1 ALLOWANCE SCHEDULE


	WINDOW & EXTERIOR DOOR SCHEDULE						11/15/2023				
UNIT	LOCATION	TYPE	SIZE (APPROXIMATE)	MANUFACTURER	STYLE	MODEL#	EXTERIOR COLOR	INTERIOR COLOR	U-FACTOR SHGC NOTES		
B-1	BARN LOUNGE	Α	12'-0" x 8'-0"	ANDERSEN	GLIDING PATIO DOOR	ABPAT12080	AAMA 2605 - DARK ASH	DARK ASH	0.31 0.29 KEYED ALIKE		
B-2	BARN LOUNGE	Α	12'-0" x 8'-0"	ANDERSEN	GLIDING PATIO DOOR	ABPAT12080	AAMA 2605 - DARK ASH	DARK ASH	0.31 0.29 KEYED ALIKE		
B-3	CHANGING ROOM	В	5'-7" x 2'-9"	ANDERSEN	AWNING		AAMA 2605 - DARK ASH	DARK ASH	"WHITE LAMINATE" PRIVACY GLASS		
B-4	CHANGING ROOM	Н	2'-9" x 7'-3"	ANDERSEN	INSWING DOOR		AAMA 2605 - DARK ASH	DARK ASH	WHITE LAMINATE" PRIVACY GLASS (NO KEY LOCK)		
B-5	ALCOVE	D	3'-0" x 4'-0"	ANDERSEN	CASEMENT	CAX3040	AAMA 2605 - DARK ASH	DARK ASH	TEMPERED GLAZING		
B-6	BARN STORAGE	С	2'-9" x 7'-3"	UPSTATE DOOR	INSWING DOOR		ALASKAN YELLOW CEDAR				
B-7	BARN STORAGE LOFT	E	5'-8" x 7'-4"	ANDERSEN	SPECIALTY SHAPE - TRAPEZOID	CUSTOM	AAMA 2605 - DARK ASH	DARK ASH	0.33 0.29 MATCH ROOF PITCH, TEMPERED GLAZING (SUBMIT SHOP DRAWINGS)		
B-8	BARN STORAGE LOFT	E	5'-8" x 7'-4"	ANDERSEN	SPECIALTY SHAPE - TRAPEZOID	CUSTOM	AAMA 2605 - DARK ASH	DARK ASH	0.33 0.29 MATCH ROOF PITCH, TEMPERED GLAZING (SUBMIT SHOP DRAWINGS)		
B-9	BARN STORAGE LOFT	F	2'-8" x 4'-0"	ANDERSEN	CASEMENT	CAX2840	AAMA 2605 - DARK ASH	DARK ASH	0.33 0.29 "WHITE LAMINATE" PRIVACY GLASS		
B-10	BARN STORAGE LOFT	G	30" x 45"	VELUX	OPERABLE SKYLIGHT		QUAKER BRONZE	PAINTED, TBD	0.41 0.23 MANUAL OPERATION, AUTOMATIC SHADES (COLOR TBD), UNFINISHED WOOD INTERIOR		
B-11	BARN STORAGE LOFT	G	30" x 45"	VELUX	OPERABLE SKYLIGHT		QUAKER BRONZE	PAINTED, TBD	0.41 0.23 MANUAL OPERATION, AUTOMATIC SHADES (COLOR TBD), UNFINISHED WOOD INTERIOR		
B-12	BARN STORAGE LOFT	G	30" x 45"	VELUX	OPERABLE SKYLIGHT		QUAKER BRONZE	PAINTED, TBD	0.41 0.23 MANUAL OPERATION, AUTOMATIC SHADES (COLOR TBD), UNFINISHED WOOD INTERIOR		


EXTERIOR DOOR & WINDOW GENERAL NOTES:


- 1 WINDOWS TO BE "ANDERSEN" ' E-SERIES'. CUSTOM EXTENSION JAMBS BY OTHERS. ALL GLAZING TO BE HIGH-PERFORMANCE LOW-E4. FULL DIVIDED LITE WITH SPACER AND 7/8" CONTEMPORARY MUNTIN BAR DIVISIONS AS PER ELEVATIONS WITH SQUARE STICKING
- 2 DOORS TO BE "ANDERSEN" ' E-SERIES'. CUSTOM EXTENSION JAMBS BY OTHERS. ALL GLAZING TO BE HIGH-PERFORMANCE LOW-E4. FULL DIVIDED LITE WITH SPACER AND 7/8" CONTEMPORARY MUNTIN BAR DIVISIONS AS PER ELEVATIONS WITH SQUARE STICKING
- 3 WINDOWS TO RECEIVE 'CONTEMPORARY' HARDWARE (OIL RUBBED BRONZE) DOORS TO RECEIVE 'ANVERS' HARDWARE (OIL RUBBED BRONZE HARDWARE & HINGES)
- 4 ALL DOORS AND WINDOWS "DARK ASH" EXTERIOR & INTERIOR FINISH. ALL SCREENS IN WINDOWS & DOORS TO BE "TRUSCENE". PRICE TO INCLUDE SCREENS FOR ALL DOORS. ALL DOORS TO RECEIVE STANDARD GRAY SILL
- 5 HEIGHTS AND WIDTHS LISTED ABOVE ARE APPROXIMATE AND ARE NOT TO BE USED FOR FRAMING ROUGH OPENINGS. PROVIDE SHOP DRAWINGS FOR APPROVAL PRIOR TO ORDERING. CONFIRM EXACT OPENING SIZES WITH WINDOW ORDER / SHOP DRAWINGS PRIOR TO FRAMING.
- 6 NO FINGER JOINED MATERIAL TO BE USED ON ANY PART OF WINDOW OR DOORS INCLUDING BUT NOT LIMITED TO, SECONDARY SURFACES, SUB SILL, EXTERIOR CASINGS, BLIND STOPS, ETC. 7 ALL EXTERIOR DOORS AND WINDOWS TO BE INSTALLED AS PER MANUFACTURER'S SPECIFICATIONS


2 EXTERIOR DOOR & WINDOW SCHEDULE

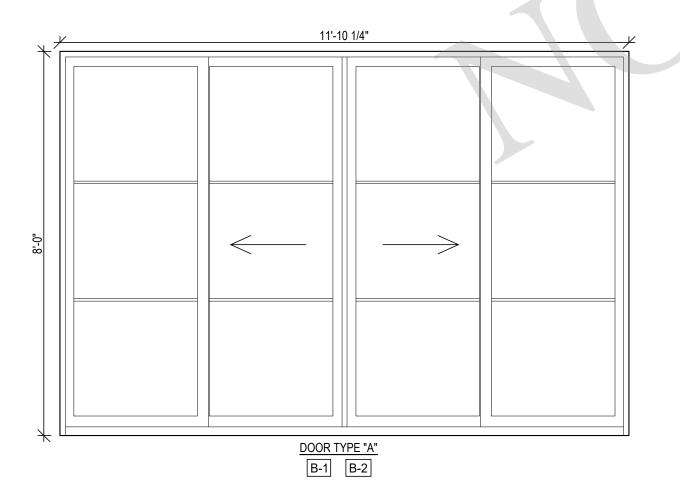


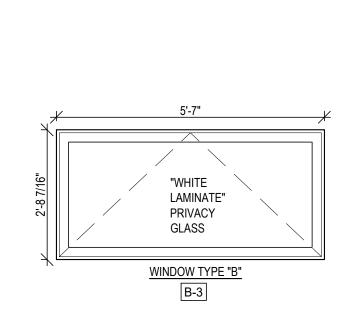


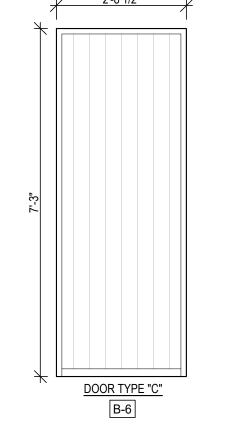


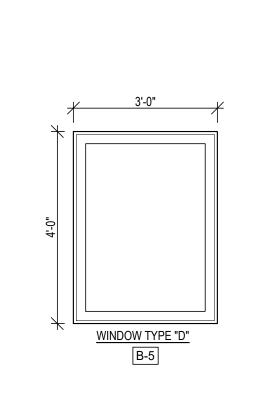

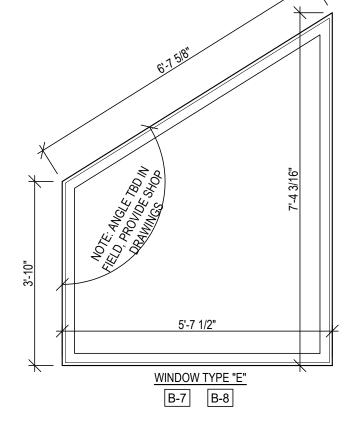

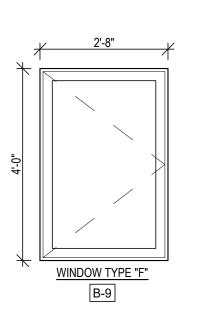

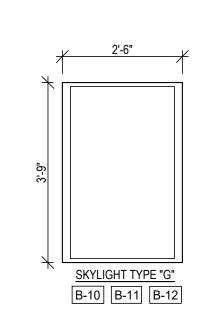

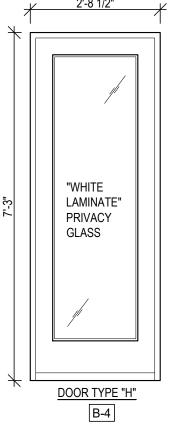

3 WINDOW & DOOR TYPES
A-600

CHECKED BY: JP

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ARCHITECT

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PROJECT NO.: 2106

WINDOW & DOOR

SCHEDULE, ALLOWANCE


DATE: 6/16/2021

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SCHEDULE

SCALE: AS NOTED

ARCHITECT P.C. JPA

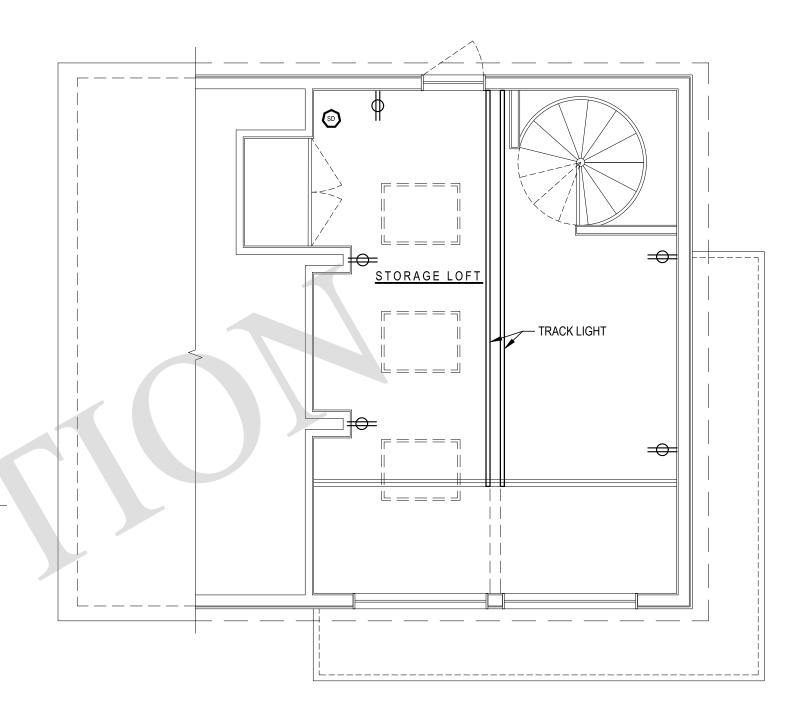

3 PROPOSED LOFT LIGHTING PLAN



LIGHTING & ELECTRICAL GENERAL NOTES:

- COORDINATE ELECTRICAL PLANS WITH REFLECTED CEILING PLANS AND INTERIOR ELEVATIONS FOR ALL FIXTURE, OUTLET & SWITCH LOCATIONS. CONFIRM EACH LOCATION WITH ARCHITECT PRIOR TO FINAL INSTALLATION.
- CONTRACTOR TO COORDINATE FULL ELECTRICAL & LIGHTING SCOPE OF WORK WITH LIGHTING CONSULTANT, A/V
- CONSULTANT, SECURITY CONSULTANT, INTERIOR DESIGNER & ARCHITECT. B. RECESS ALL APPLIANCE OUTLETS AND REFER TO MANUFACTURER FOR SPECIFICATIONS AND FINAL LOCATIONS.
- I. CONTRACTOR SHALL INSTALL ALL FIXTURES SUPPLIED BY THE OWNER AS PER LIGHTING FIXTURE SCHEDULE.
- 5. CONTRACTOR TO CONFIRM COVER SWITCH, OUTLET & DIMMER STYLES WITH ARCHITECT. ALL SWITCHES AND KEY PAD TYPES TO BE CONFIRMED.
- . ALL REMOTE TRANSFORMERS FOR LOW VOLTAGE/LED LIGHTING TO BE LOCATED ON SITE WITH ARCHITECT.
- CONTRACTOR TO REVIEW FINAL LOCATIONS FOR THERMOSTATS AND TEMPERATURE SENSORS ON SITE WITH ARCHITECT PRIOR TO INSTALLATION.
- CONTRACTOR TO VERIFY LIGHT FIXTURES AND ELECTRICAL DEVICES COUNT ON ALL FLOORS. ELECTRICAL CONTRACTOR TO CONFIRM IF ADDITIONAL SMOKE DETECTORS AND/OR CARBON MONOXIDE DETECTORS ARE REQUIRED AS PER BUILDING CODE FROM WHAT HAS OTHERWISE BEEN INDICATED ON THE PROPOSED ELECTRICAL PLANS.
- CONTRACTOR TO REFER TO MECHANICAL ENGINEER'S ELECTRICAL & POWER PLANS FOR ALL EQUIPMENT REQUIREMENTS, SIZES AND SPECIFICATIONS.
- 10. CONTRACTOR TO COORDINATE WITH ELECTRICAL CONTRACTOR, A/V CONTRACTOR, AND SECURITY CONTRACTOR FOR THE INSTALLATION AND THE RUNNING OF ALL LOW VOLTAGE WIRES AS PART OF EACH CONTRACTOR'S SCOPE OF WORK.

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ELECTRICAL SYMBOL LEGEND

DECORATIVE SURFACE MOUNTED LIGHT FIXTURE

3" SQUARE CEILING RECESSED LIGHT FIXTURE

-- CEILING SURFACE MOUNTED UTILITY LIGHT

H中 WALL MOUNTED LIGHT

CLOSET LIGHT

├● TV OUTLET

EXHAUST FAN

DIMMER SWITCH, UNLESS OTHERWISE NOTED

DUPLEX OUTLET

DUPLEX SPECIAL PURPOSE OUTLET

GROUND FAULT INTERRUPTER OUTLER

FLOOR OUTLET

SMOKE DETECTOR

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PROPOSED ELECTRICAL PLANS

SCALE: AS NOTED